

THE SCHOOL BOARD OF VOLUSIA **COUNTY FLORIDA** 200 North Clara Avenue Deland, Florida 32720

DAVID C. HINSON, SR. MIDDLE SCHOOL REPLACE GUTTERS AND DOWNSPOUTS VCS Project NO. 2247853

1860 N. CLYDE MORRIS BLVD. DAYTONA BEACH, FL 32117

SCHOOL BOARD MEMBERS

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DESCRIPTION OF WORK

REPLACEMENT OF GUTTERS AND DOWNSPOUTS ON ROOFS THROUGHOUT THE CAMPUS

Architect's Statement of Compliance To the best of my knowledge, these drawings and the project manual are complete and comply with

BUILDING DATA

the Florida Building Code.

C. OCCUPANCY TYPE E. RISK CATEGORY G. BUILDING AREA 15 FT (STEEP SLOPED ROOFS) H. BUILDING HEIGHT I. OCCUPANT LOAD

LOCATION MAP



ENGINEERS & CONSULTANTS

FIRM NAME: GALE ASSOCIATES \SOUTH\, INC. ADDRESS: 160 N. WESTMONTE DRIVE SUITE 1200 ADDRESS: ALTAMONTE SPRINGS, FL 32714 EMAIL ADDRESS: ASC@GAINC.COM


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COVER SHEET STANDARD LEGEND, SYMBOLS AND GENERAL NOTES ROOF PLAN BLDGS 1,2 AND 10 ROOF PLAN BLDGS 3 AND 7 ROOF PLAN BLDGS 4 AND 8 ROOF PLAN BLDGS 5 AND 9 **ROOF PLAN BLDG 6**

DETAILS DETAILS DETAILS DETAILS



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ENGR OF RECORD ALAN S. CRAIGO, P.E. FKL/EM AEA/EM 10/14/2022

G001

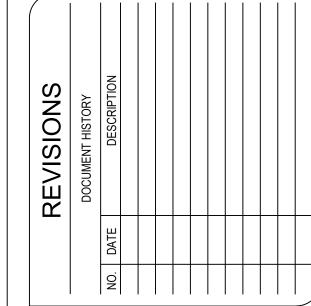COVER SHEET

CONSTRUCTION DOCUMENTS 10/14/2022

GENERAL NOTES

DESCRIPTION OF WORK

THE GENERAL SCOPE OF WORK FOR THIS PROJECT INCLUDES REPLACEMENT OF GUTTERS AND DOWNSPOUTS THROUGHOUT CAMPUS, AS INDICATED ON THE DRAWINGS.

DEMOLITION NOTES


- 1. THE INFORMATION SHOWN ON THE DRAWINGS HAS BEEN COMPILED FROM VARIOUS SOURCES, AND MAY NOT REFLECT THE ACTUAL CONDITIONS AT THE TIME OF CONSTRUCTION. CONTRACTOR SHALL FIELD VERIFY ALL DIMENSIONS AND QUANTITIES PRIOR TO BID.
- 2. THE BUILDING WILL REMAIN OCCUPIED DURING CONSTRUCTION. THE CONTRACTOR SHALL SCHEDULE AND EXECUTE WORK TO AVOID INTERRUPTIONS TO BUILDING OPERATIONS.
- 3. CONTRACTOR SETUP LOCATIONS SHALL BE AS INDICATED BY THE OWNER DURING THE PRE-CONSTRUCTION MEETING.
- 4. THE CONTRACTOR SHALL BE RESPONSIBLE FOR COVERING ALL INTERIOR ITEMS THAT MIGHT BE AFFECTED BY THE WORK, INCLUDING FLOORS AND EQUIPMENT PRIOR TO DEMOLITION. ONCE REMOVAL IS COMPLETE FOR THE DAY, THE PLASTIC COVERINGS SHALL BE REMOVED AND THE INTERIOR AREAS CLEANED. CLEANING SHALL INCLUDE, BUT NOT BE LIMITED TO, SWEEPING OF FLOORS AND DUST REMOVAL FROM THE TOPS OF LIGHT FIXTURES AND EQUIPMENT WHERE ACCESSIBLE.
- 5. THE CONTRACTOR SHALL REPORT DETERIORATED OR UNSUITABLE ROOF DECK OR SUBSTRATE COMPONENTS TO THE OWNER PRIOR TO PERFORMING ROOFING INSTALLATION.
- 6. REMOVE AND DISPOSE OF EXISTING GUTTER AND DOWNSPOUT COMPONENTS, DOWN TO THE EXISTING SUBSTRATES AS INDICATED. EXISTING COMPONENTS NOT DESIGNATED FOR REMOVAL SHALL REMAIN IN PLACE AND SHALL BE PROTECTED FROM DAMAGE BY THE SUBSEQUENT WORK, DECK UNLESS OTHERWISE INDICATED ON THE DETAIL DRAWINGS. REMOVE AND DISPOSE OF ALL ITEMS TO INCLUDE GUTTERS, BRACKETS, STRAPS, DOWNSPOUTS, ASSOCIATED HARDWARED, ETC. SCHEDULED TO BE REMOVED. TEMPORARILY REMOVE ANY COMPONENT OR ASSEMBLY AS REQUIRED TO FACILITATE THE GUTTER AND DOWNSPOUT REPLACEMENT WORK, AND RESTORE TO ITS ORIGINAL AND WATERTIGHT CONDITION.
- 7. CORROSION TREAT AND PAINT (OR SEAL) ALL VACANT FASTENER HOLES IN EXISTING METAL ASSEMBLIES THAT ARE DESIGNATED TO REMAIN, AND THAT ARE AFFECTED BY THE SCOPE OF THIS WORK.
- 8. PROVIDE TEMPORARY OVERHEAD PROTECTION AT THE MAIN ENTRANCES TO BUILDINGS AND AT OTHER LOCATIONS AS NECESSARY TO PROVIDE UNINTERRUPTED AND SAFE ACCESS TO BUILDING.
- 9. REMOVALS SHALL BE PERFORMED IN ACCORDANCE WITH THE SUBMITTED AND APPROVED REMOVAL PLAN, THE DETAIL DRAWINGS AND SPECIFICATIONS.

INSTALLATION NOTES

- 1. FOR THE SAKE OF CLARITY, EACH INDIVIDUAL DETAIL ON THE ROOF PLANS HAS NOT BEEN INDICATED. EXISTING AND NEW DETAILS HAVE BEEN INDICATED FOR TYPICAL COMPONENTS AT RANDOM LOCATIONS.
- 2. COMPONENTS SHOWN ON THE DETAIL DRAWINGS SHALL BE NEW UNLESS SPECIFICALLY INDICATED AS EXISTING.
- 3. ITEMS OF CONSTRUCTION SHALL BE IN ACCORDANCE WITH LOCAL, STATE, AND FEDERAL REGULATIONS APPLICABLE TO THE PROJECT.
- 4. FOR THE SAKE OF CLARITY, SECUREMENT FASTENERS ARE NOT SHOWN ON THE DRAWINGS IN THEIR ENTIRETY. REFER TO SPECIFICATIONS FOR FASTENER TYPES/SPACING.
- 5. ANY DISCREPANCIES ON THE DRAWINGS NOTED BY THE CONTRACTOR SHALL BE BROUGHT TO THE OWNER'S ATTENTION PRIOR TO BID SUBMISSION.
- 6. ITEMS OF CONSTRUCTION SHALL BE 100% WATERTIGHT ON THE SAME DAY OF WORK. PHASED CONSTRUCTION MUST BE APPROVED BY THE OWNER PRIOR TO CONSTRUCTION.
- 7. DETAILS NOT DEPICTED SHALL BE CONSTRUCTED IN A MANNER CONSISTENT WITH THE DETAIL DRAWINGS. FIELD VERIFY ALL DIMENSIONS AND QUANTITIES.
- 8. IF THERE IS A POTENTIAL HAZARDOUS MATERIAL ENCOUNTERED DURING THE COURSE OF WORK THAT IS NOT IDENTIFIED IN THE CONTRACT DOCUMENTS, THE CONTRACTOR WILL STOP WORK IMMEDIATELY AND CONTACT THE OWNER WHO IS TO MAKE A DETERMINATION IF THE MATERIAL IS HAZARDOUS.
- 9. ALL DUMPSTERS MUST BE AT LEAST 15 FEET FROM THE BUILDING UNLESS EMPTIED AT THE END OF EACH WORK DAY.
- 10. MATERIALS MAY NOT BE STORED CLOSER THAN 15 FEET FROM BUILDINGS AND MAY NOT BE PLACED IN FRONT OF EXITS OR ANY FIRE PROTECTION EQUIPMENT. REFUELING OF GASOLINE POWERED EQUIPMENT WILL NOT BE PERMITTED ON THE ROOF. GASOLINE MUST BE STORED IN UL LISTED AND APPROVED CONTAINERS.
- 11. METAL FABRICATION NOTES: FILE SMOOTH ALL EXPOSED SHARP EDGES. FABRICATE METAL TRANSITIONS AND TERMINATIONS IN ONE-PIECE CONSTRUCTION. LOCK AND SEAL OR SOLDER ALL JOINTS SOLID, AS SPECIFIED, TO MAKE WATERTIGHT.
- 12. SHEET METAL FABRICATION DETAILS HAVE BEEN PROVIDED TO REPRESENT TYPICAL CONDITIONS, THEY MAY NOT REPRESENT EVERY UNIQUE CONDITION REQUIRED TO COMPLETE THE WORK; HOWEVER, SUCH FABRICATIONS SHALL BE REQUIRED AS IF SHOWN ON THE DRAWINGS. CONTRACTOR SHALL PREPARE AND SUBMIT SHOP DRAWINGS OF SUCH CONDITIONS TO THE ENGINEER OF RECORD FOR REVIEW AND APPROVAL PRIOR TO SHOP FABRICATION OR FIELD INSTALLATION.


STATEMENT OF COMPLIANCE

- 1. TO THE BEST OF MY KNOWLEDGE, THESE DRAWINGS AND THE PROJECT MANUAL ARE COMPLETE AND COMPLY WITH THE FLORIDA BUILDING CODE.
- 2. BUILDING CODE REFERENCE: FLORIDA BUILDING CODE, 7TH EDITION (2020).

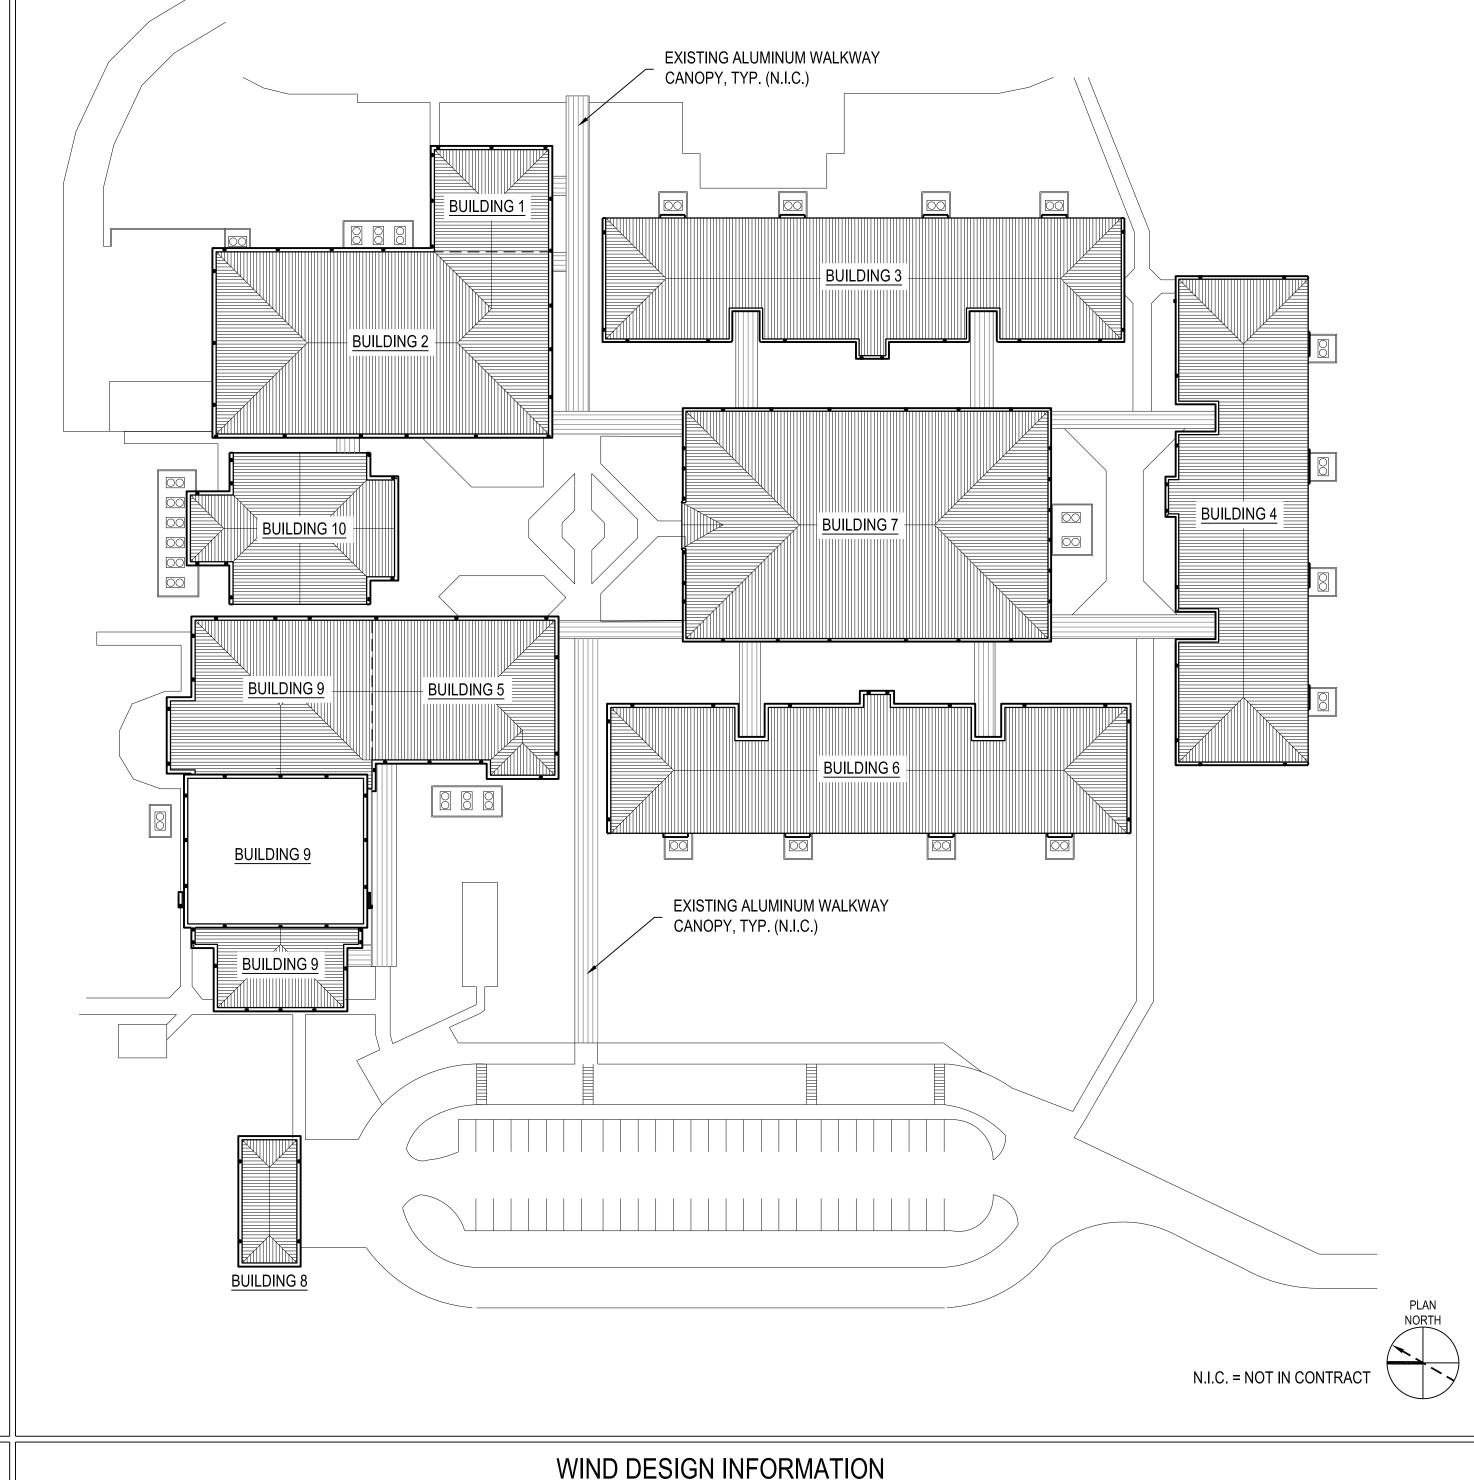


OVERALL CAMPUS PLAN

STANDARD LEGEND AND SYMBOLS **ROOF AREA SUMMARY** NOTE: NOT ALL SYMBOLS NECESSARILY USED BLDG.# **ROOF SQUARE FOOTAGE GUTTER LINEAR FOOTAGE** ROOF EDGE 5,000 SF. 220 LF. **GUTTER WITH DOWNSPOUT** 2 26,500 SF. 590 LF. **GUTTER EXPANSION JOINT** 26,500 SF. 500 LF. **EXPANSION JOINT** 27,500 SF. 500 LF. 12,000 SF. 350 LF. **DETAIL IDENTIFIER** 27,500 SF. 500 LF. A500 35,500 SF. 770 LF. SHEET WHERE DETAIL S SHOWN 3,100 SF. 250 LF. DETAIL INDICATOR 9 28,700 SF. 670 LF. **DETAIL IDENTIFIER** 10 11,500 SF. 100 LF. 203,800 SF. 4,450 LF. TOTAL (A500 SHEET WHERE DETAIL S SHOWN TABLE LEGEND NOTE: QUANTITIES ARE PROVIDED TO ASSIST BIDDERS IN ESTABLISHING THE SF = SQUARE FEET PROJECT SCOPE. FIELD VERIFY ALL EXISTING CONDITIONS, DIMENSIONS AND SECTION INDICATOR LF = LINEAR FEET QUANTITIES PRIOR TO SUBMITTING A BID FOR THIS PROJECT.

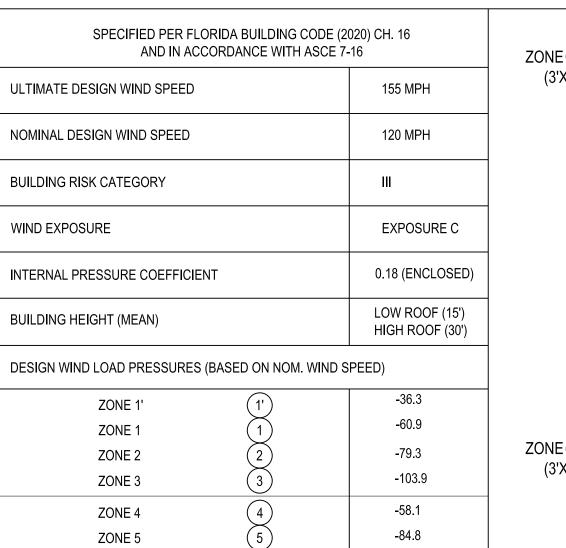

ZONE 6

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ARCH/ENGR OF RECORD
ENGR OF RECORD
ALAN S. CRAIGO, P.E.

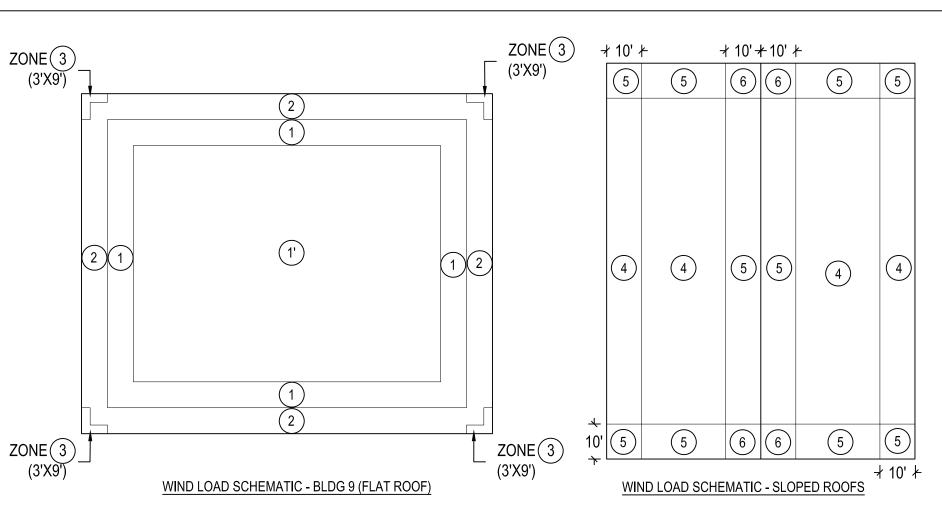DESIGNED BY
AEA/EM


ISSUE DATE
10/14/2022

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DRAWN BY
FKL/EM

AE PROJECT NUMBER
678279

STANDARD LEGEND, SYMBOLS AND GENERAL NOTES

G002

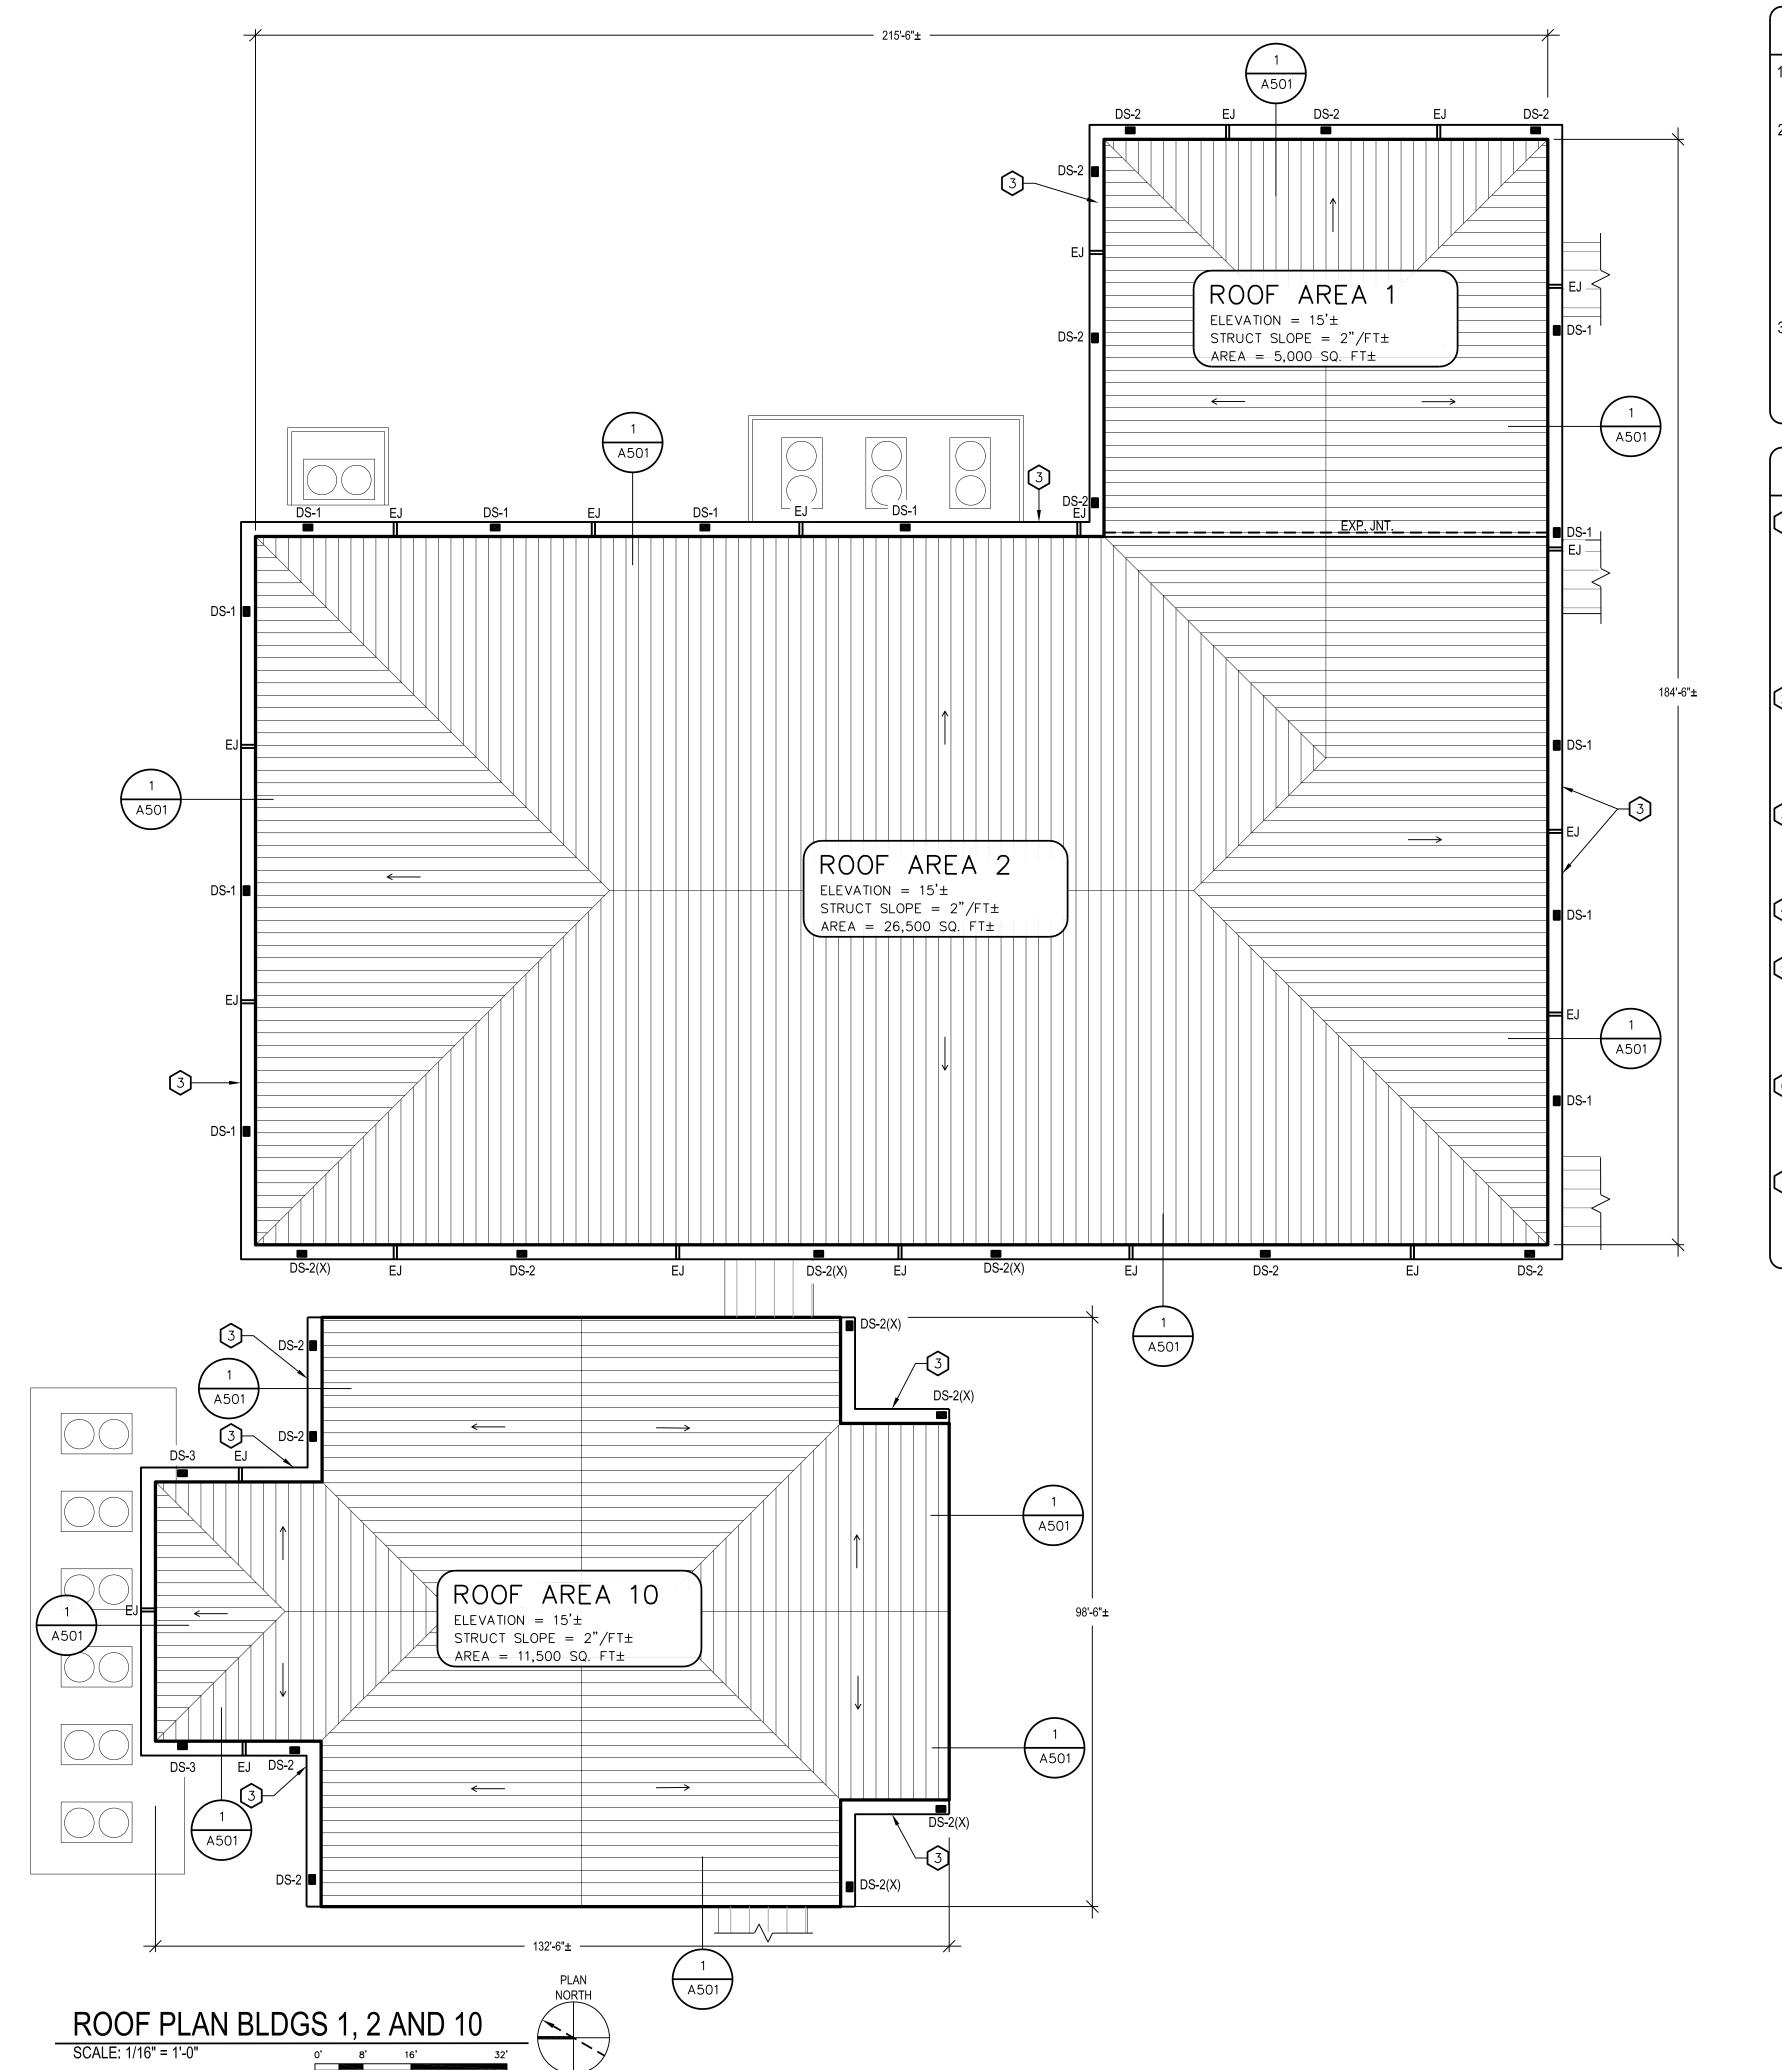

GUTTER REPLACEMENT NOTES

- 1. REMOVE AND REPLACE ALL GUTTERS AND DOWNSPOUTS AS INDICATED. REFER TO DOWNSPOUT SCHEDULE, DETAIL 3/A503, FOR TYP. DOWNSPOUT PROFILES (DS #).
- FABRICATE BOTTOM SECTIONS OF DOWNSPOUTS OUT OF EXTRUDED ALUMINUM AS SPECIFIED, ALL LOCATIONS UNLESS OTHERWISE INDICATED (DOWNSPOUTS THAT DO NOT DEPOSIT DIRECTLY TO GRADE ARE NOT REQUIRED TO BE FABRICATED FROM EXTRUDED METAL, BUT MAY BE FABRICATED FROM SHEET METAL AS SPECIFIED). DOWNSPOUTS IDENTIFIED WITH AN "X" (DS # (X)) ARE LOCATIONS WHERE EXISTING DOWNSPOUTS ARE ALREADY OUTFITTED WITH EXTRUDED ALUMINUM DOWNSPOUTS. EXISTING EXTRUDED ALUMINUM DOWNSPOUT SECTIONS MAY BE CLEANED, ADJUSTED AND RE-USED IF IN GOOD CONDITION. REFER TO SPECIFICATION SECTION 012200 UNIT PRICES FOR ADDITIONAL INFORMATION.
- PROTECT EXISTING GALVALUME METAL ROOFING, WALL SYSTEMS AND ASSOCIATED TRIM FROM DAMAGE DURING THE COURSE OF GUTTER AND DOWNSPOUT REPLACEMENT. CONTRACTOR SHALL BE RESPONSIBLE FOR DAMAGE TO EXISTING ROOFING AND WALL SYSTEMS.

KEY NOTES

- WHERE GUTTER IS INSTALLED ABOVE OUTDOOR EQUIPMENT YARD, EXTEND GUTTER MIN. 4-FEET BEYOND THE EXISTING SCREEN WALL ON BOTH SIDES TO AVOID DEPOSITING RUNOFF INSIDE THE EQUIPMENT YARD AREA. PROVIDE A ONE-PIECE GUTTER AT EACH LOCATION (NO JOINTS/SEAMS IN LENGTH OF GUTTER) AND A INSTALL NEW DOWNSPOUT AT EACH END AS SHOWN. PLACE SPLASH BLOCK AT GRADE BENEATH EACH DOWNSPOUT, PLACE SO AS TO NOT INTERFERE WITH EGRESS TO EQUIPMENT YARD. REFER TO DOWNSPOUT SCHEDULE, DETAIL 3/A502 FOR TYP. DOWNSPOUT PROFILE AT THIS CONDITION.
- REMOVE EXISTING DOWNSPOUT THAT PENETRATES THROUGH EXISTING ALUMINUM WALKWAY CANOPY, CAP PENETRATION THROUGH CANOPY AND REPAIR EXISTING DOWNSPOUT SUB-GRADE RECEPTACLE LOCATION AT CONCRETE WALKWAY BELOW. RE-ROUTE NEW DOWNSPOUT TO DEPOSIT RUNOFF DIRECTLY ONTO THE EXISTING ALUMINUM WALKWAY CANOPY AS INDICATED. REFER TO DETAIL 1/A503.
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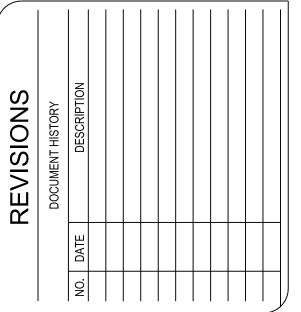
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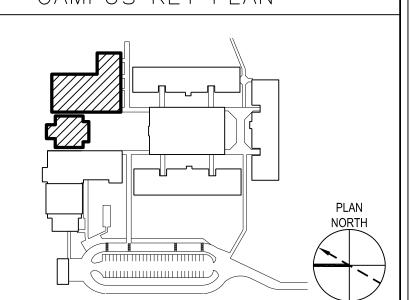
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HINSON,

DAVID

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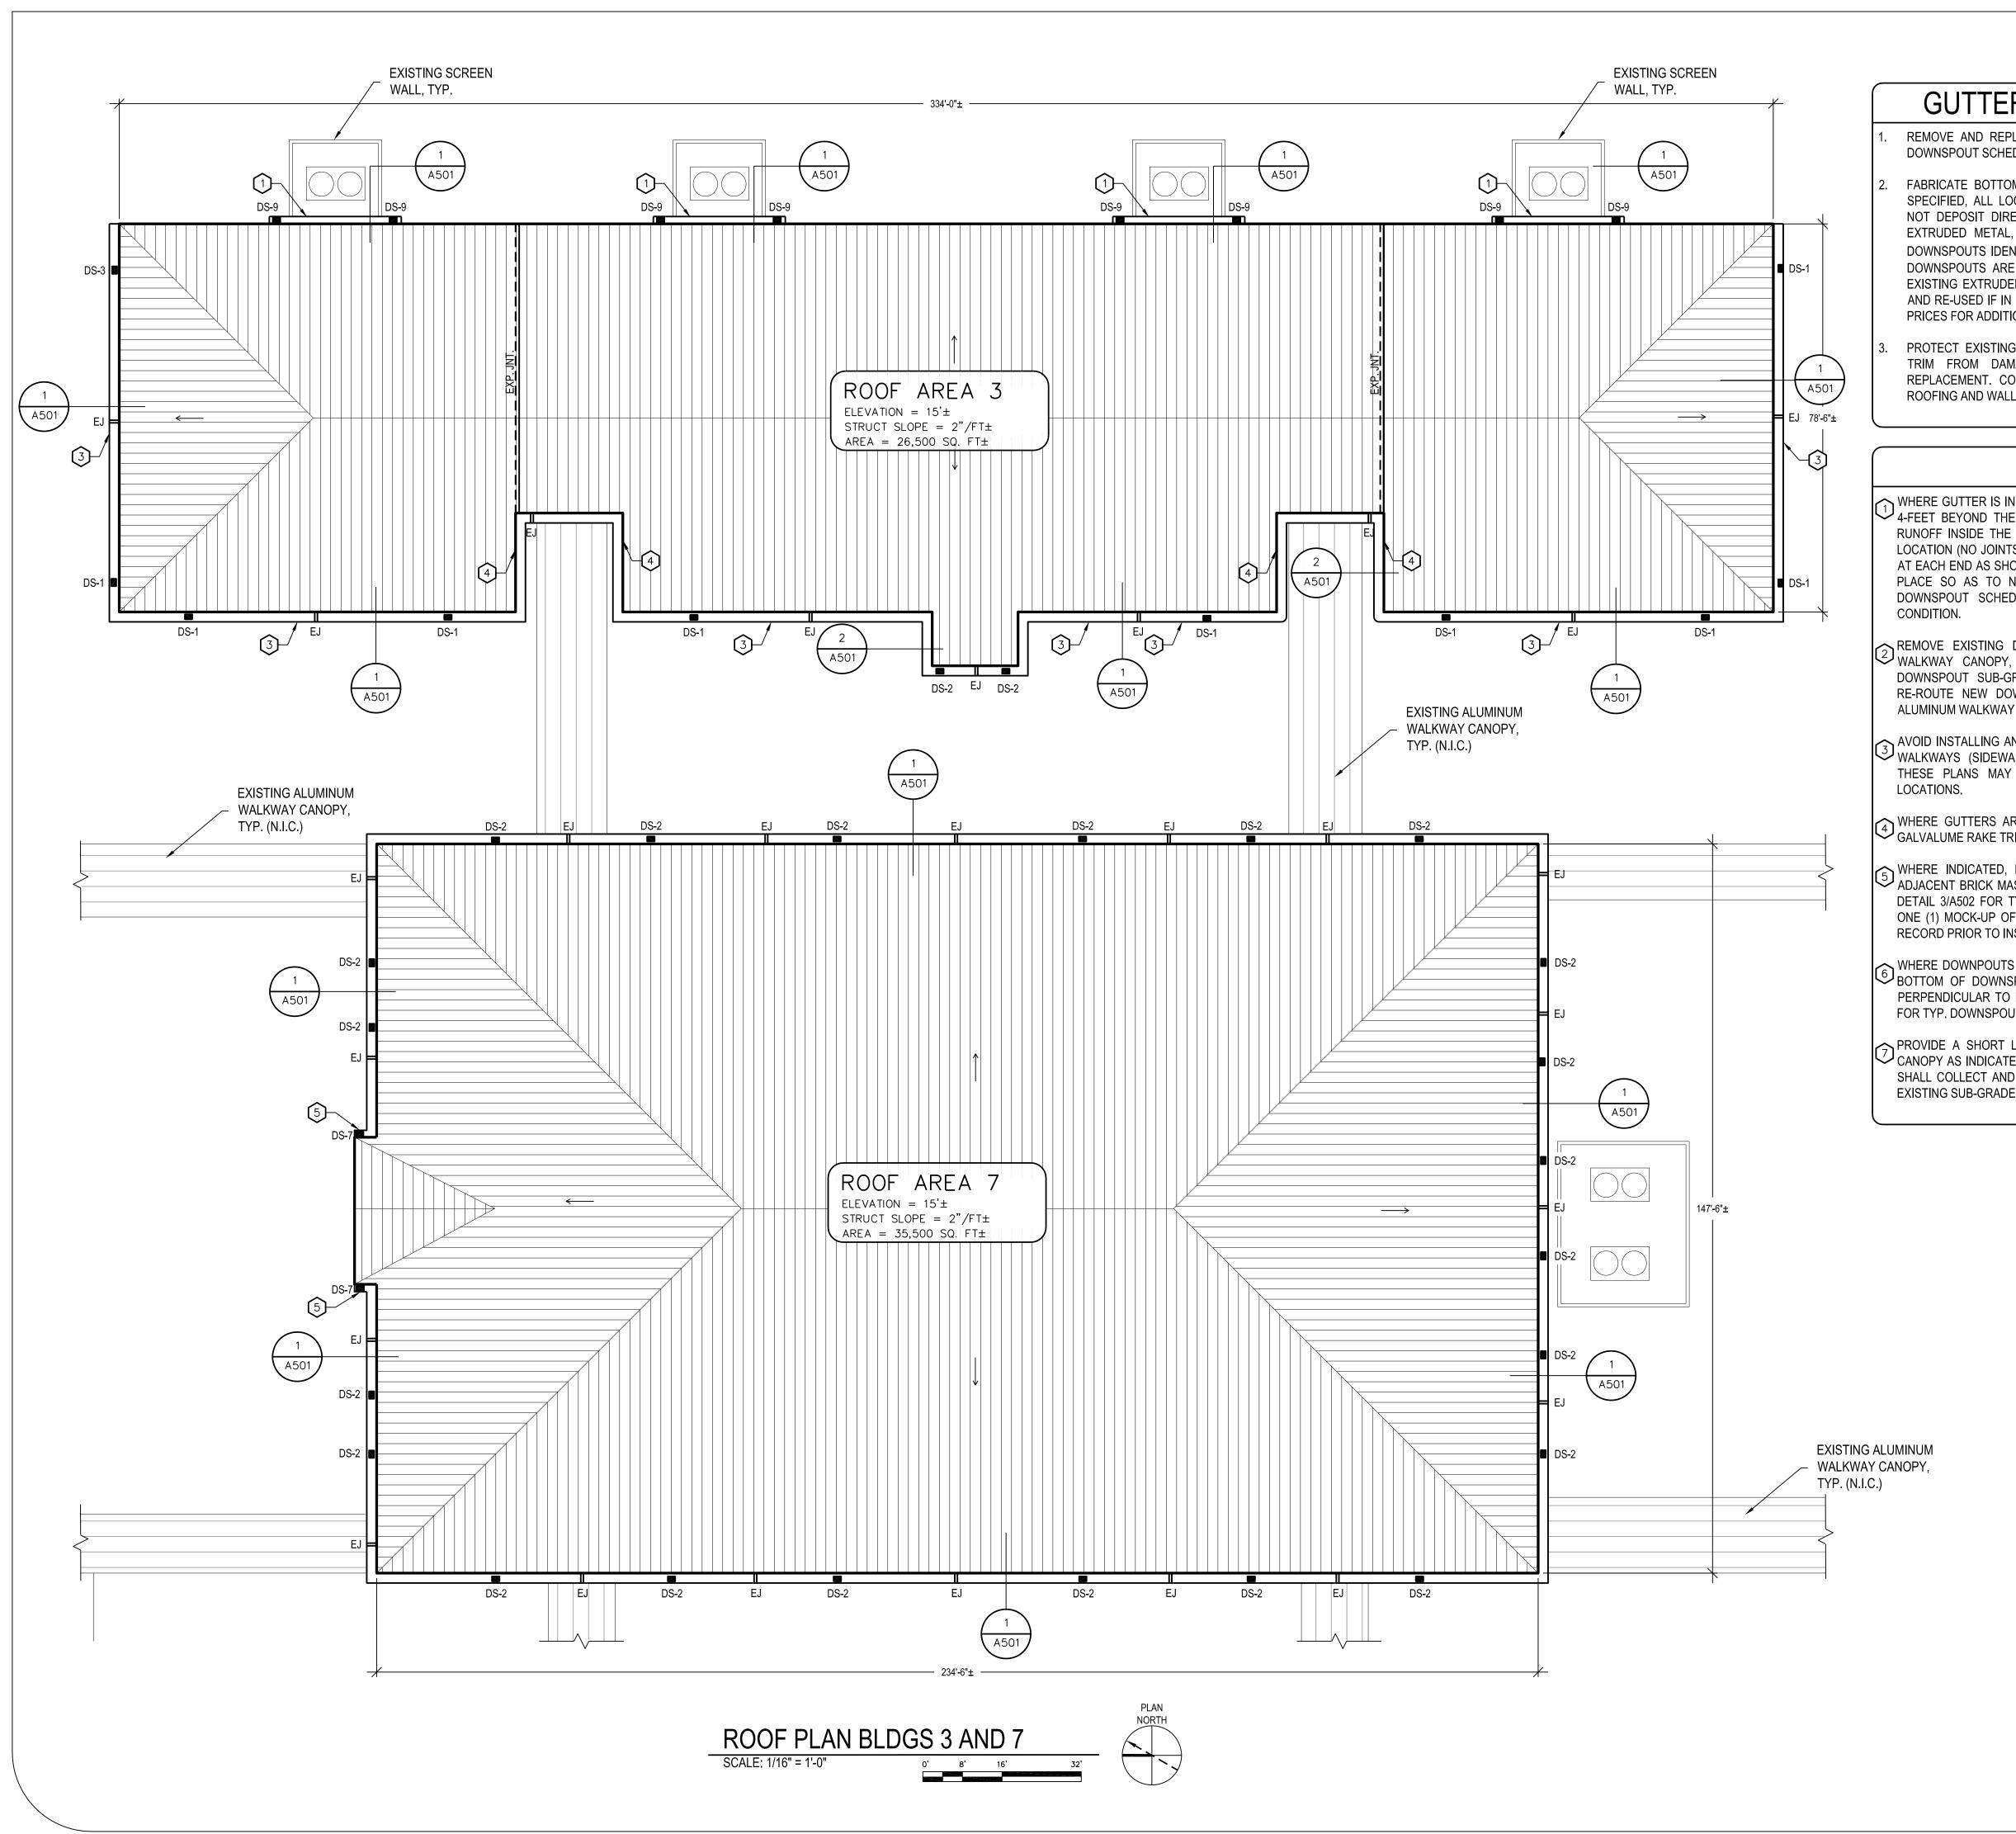
CAMPUS KEY PLAN



_		ARCH/ENGR OF RECOR
	ENGR OF RECORD ALAN S. CRAIGO), P.E.
	DESIGNED BY AEA/EM	DRAWN BY FKL/EM
	ISSUE DATE 10/14/2022	AE PROJECT NUMBER 678279
	SHEET TITLE	

ROOF PLAN BLDGS 1,2 AND 10

A101





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CAMPUS KEY PLAN




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ALAN S. CRAIGO, P.E.

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AEA/EM


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SHEET TITLE

ROOF PLAN
BLDGS 3 AND 7

DAVID

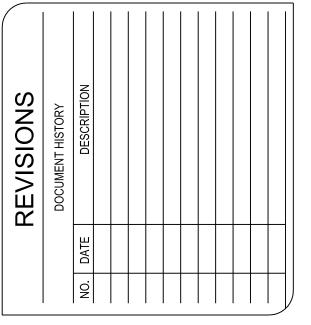ING NO. A 102

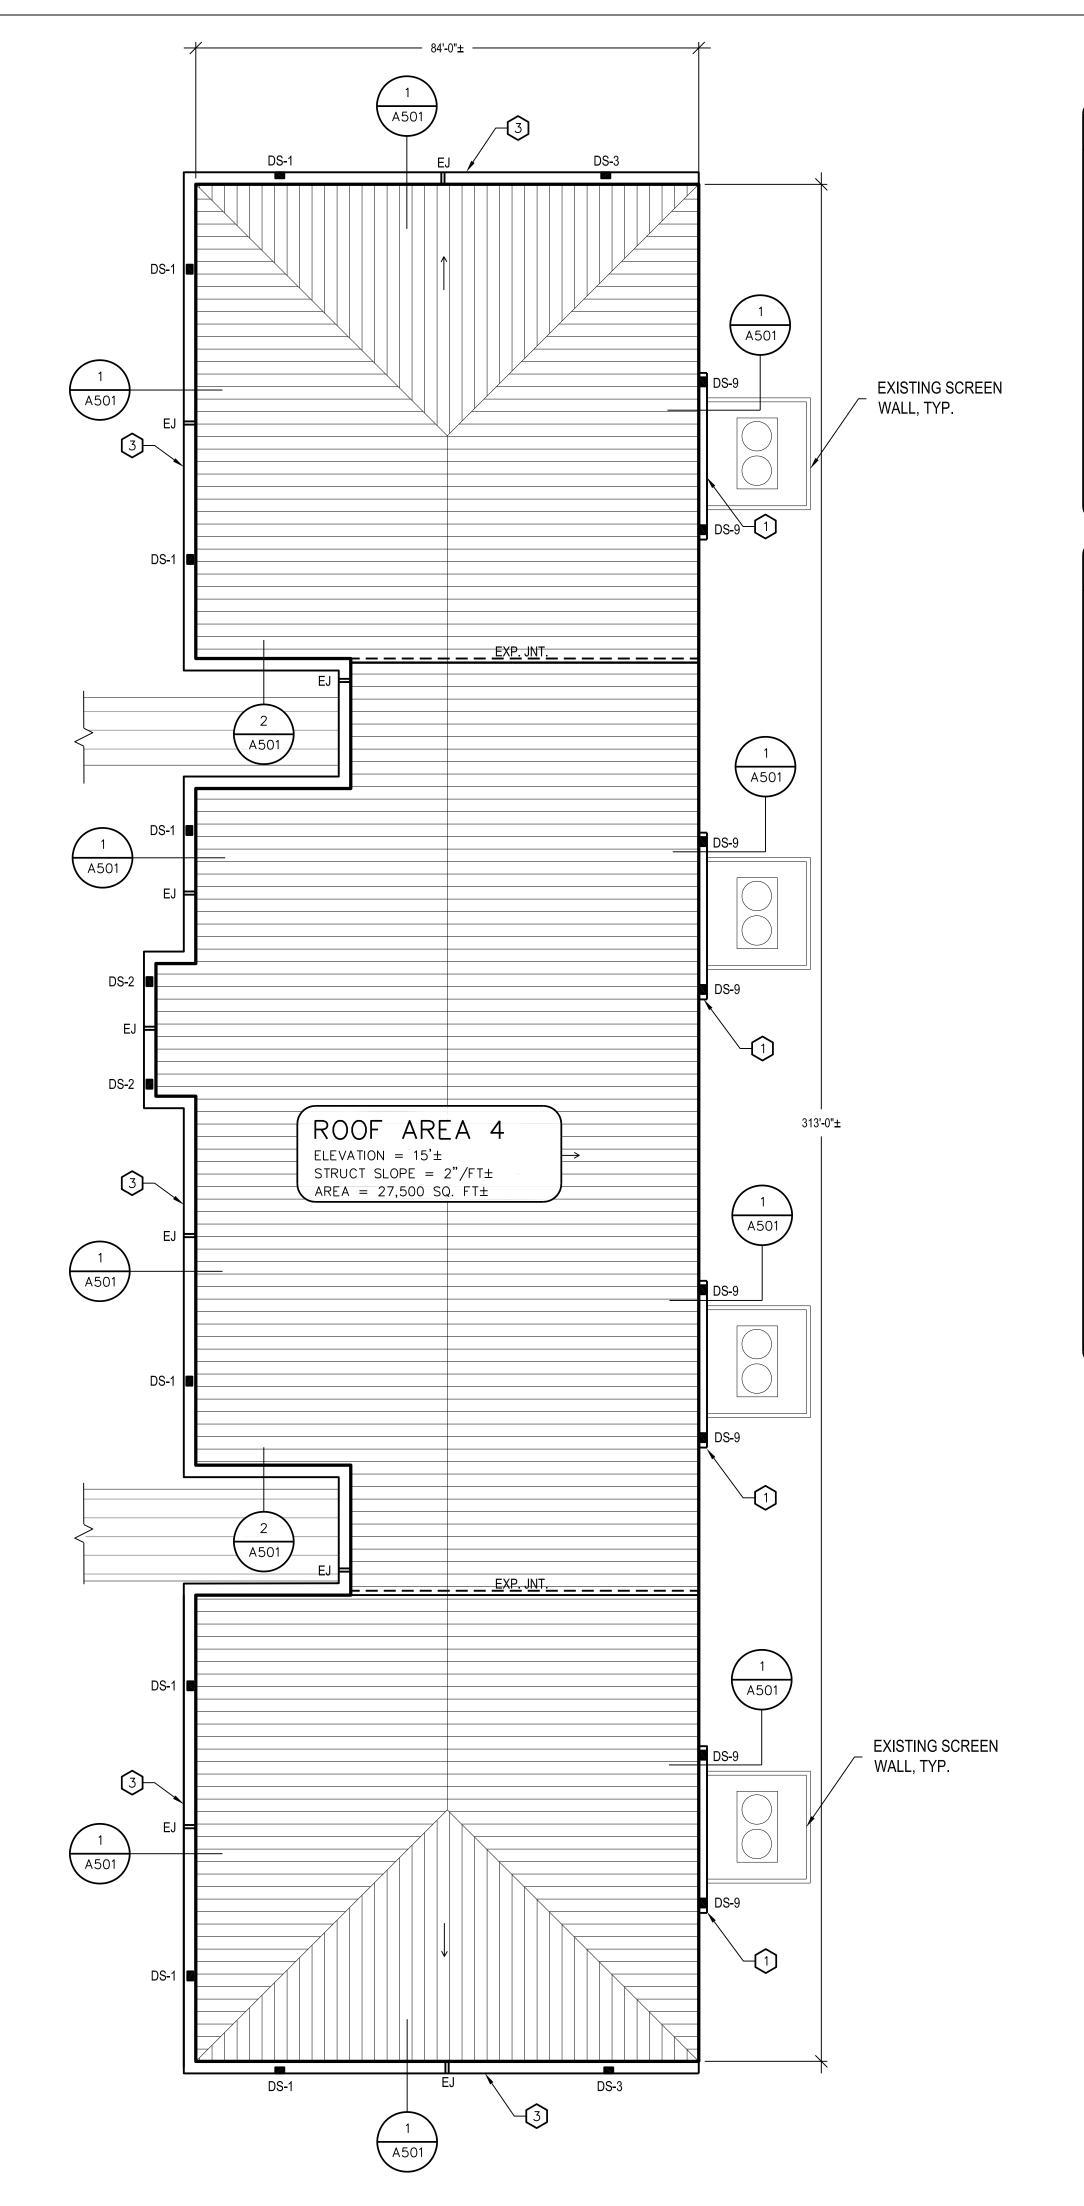

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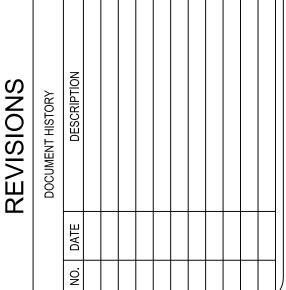
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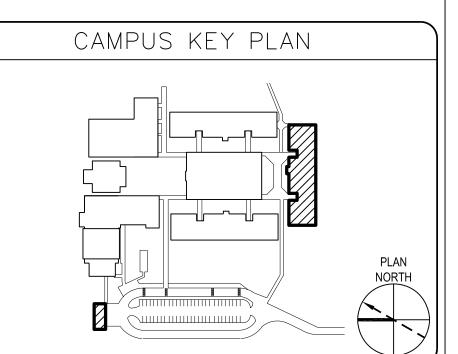


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DAYTONA BEACH, FL 32117

DAVID C. HINSON
GUTTER F
VCS Proje

MIDDLE



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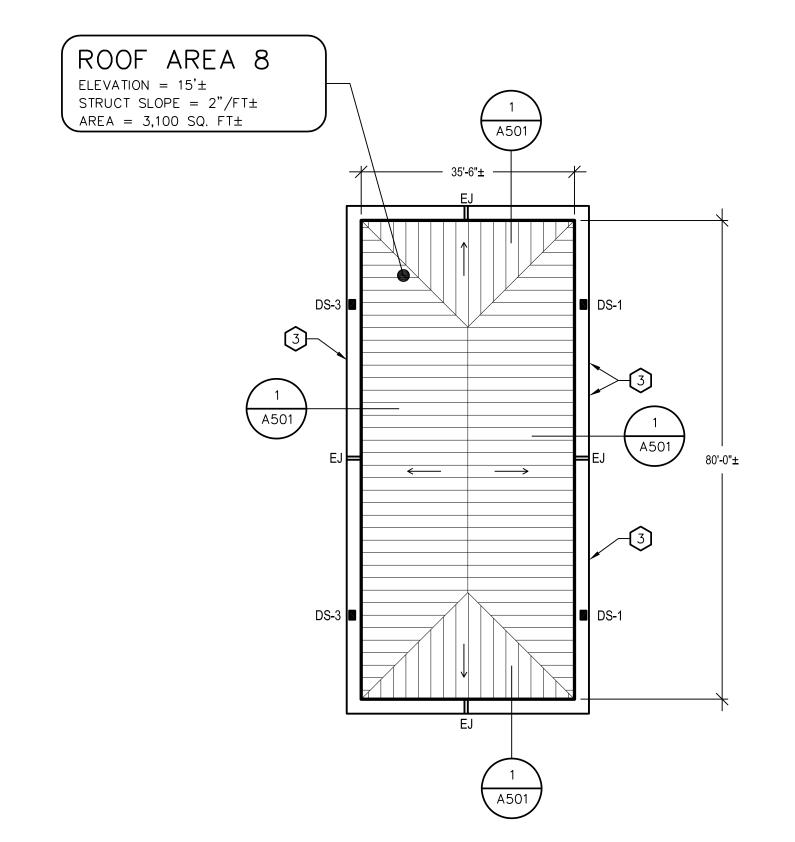
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ARCH/ENGR OF RECORD
ALAN S. CRAIGO, P.E.

DRAWN BY
AE PROJECT NUMBER
678279


ROOF PLAN BLDGS 4 AND 8

A103



ROOF PLAN BLDGS 4 AND 8

SCALE: 1/16" = 1'-0"

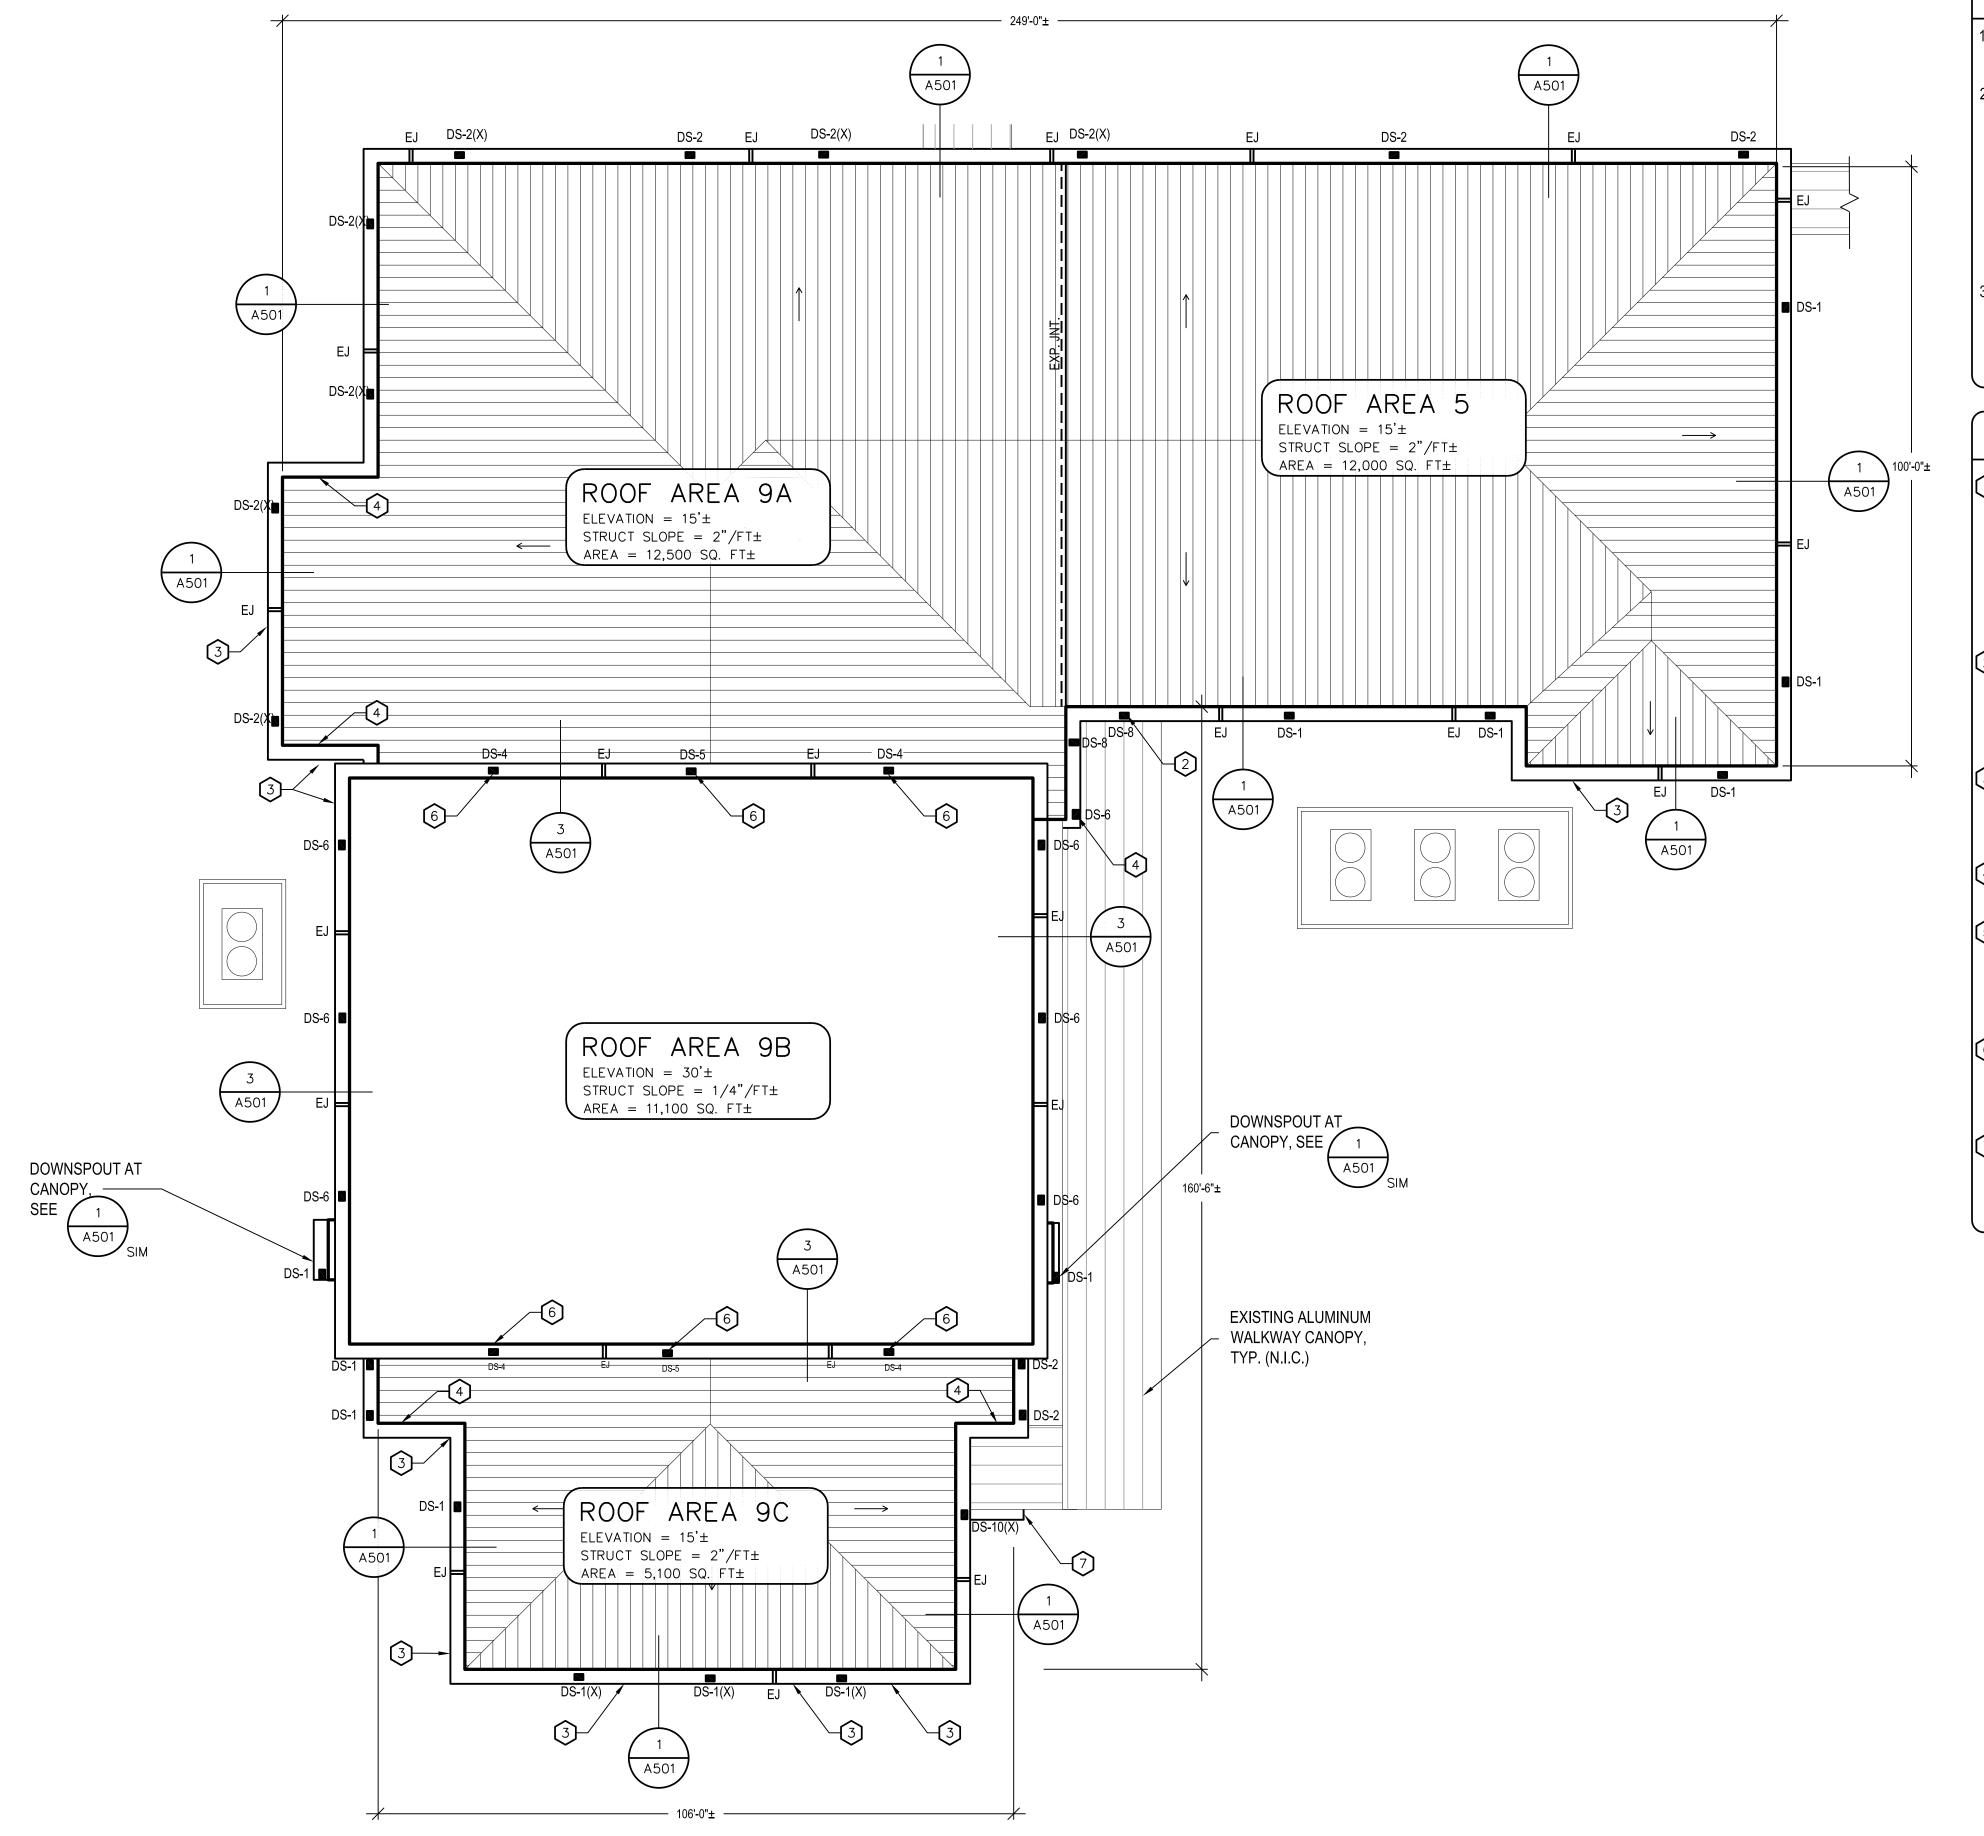

PLAN

ROOF PLAN BLDGS 5 AND 9

SCALE: 1/16" = 1'-0"

GUTTER REPLACEMENT NOTES

- 1. REMOVE AND REPLACE ALL GUTTERS AND DOWNSPOUTS AS INDICATED. REFER TO DOWNSPOUT SCHEDULE, DETAIL 3/A503, FOR TYP. DOWNSPOUT PROFILES (DS #).
- FABRICATE BOTTOM SECTIONS OF DOWNSPOUTS OUT OF EXTRUDED ALUMINUM AS SPECIFIED, ALL LOCATIONS UNLESS OTHERWISE INDICATED (DOWNSPOUTS THAT DO NOT DEPOSIT DIRECTLY TO GRADE ARE NOT REQUIRED TO BE FABRICATED FROM EXTRUDED METAL, BUT MAY BE FABRICATED FROM SHEET METAL AS SPECIFIED). DOWNSPOUTS IDENTIFIED WITH AN "X" (DS # (X)) ARE LOCATIONS WHERE EXISTING DOWNSPOUTS ARE ALREADY OUTFITTED WITH EXTRUDED ALUMINUM DOWNSPOUTS. EXISTING EXTRUDED ALUMINUM DOWNSPOUT SECTIONS MAY BE CLEANED, ADJUSTED AND RE-USED IF IN GOOD CONDITION. REFER TO SPECIFICATION SECTION 012200 UNIT PRICES FOR ADDITIONAL INFORMATION.
- PROTECT EXISTING GALVALUME METAL ROOFING, WALL SYSTEMS AND ASSOCIATED TRIM FROM DAMAGE DURING THE COURSE OF GUTTER AND DOWNSPOUT REPLACEMENT. CONTRACTOR SHALL BE RESPONSIBLE FOR DAMAGE TO EXISTING ROOFING AND WALL SYSTEMS.

KEY NOTES

- WHERE GUTTER IS INSTALLED ABOVE OUTDOOR EQUIPMENT YARD, EXTEND GUTTER MIN. 4-FEET BEYOND THE EXISTING SCREEN WALL ON BOTH SIDES TO AVOID DEPOSITING RUNOFF INSIDE THE EQUIPMENT YARD AREA. PROVIDE A ONE-PIECE GUTTER AT EACH LOCATION (NO JOINTS/SEAMS IN LENGTH OF GUTTER) AND A INSTALL NEW DOWNSPOUT AT EACH END AS SHOWN. PLACE SPLASH BLOCK AT GRADE BENEATH EACH DOWNSPOUT, PLACE SO AS TO NOT INTERFERE WITH EGRESS TO EQUIPMENT YARD. REFER TO DOWNSPOUT SCHEDULE, DETAIL 3/A502 FOR TYP. DOWNSPOUT PROFILE AT THIS CONDITION.
- REMOVE EXISTING DOWNSPOUT THAT PENETRATES THROUGH EXISTING ALUMINUM WALKWAY CANOPY, CAP PENETRATION THROUGH CANOPY AND REPAIR EXISTING DOWNSPOUT SUB-GRADE RECEPTACLE LOCATION AT CONCRETE WALKWAY BELOW. RE-ROUTE NEW DOWNSPOUT TO DEPOSIT RUNOFF DIRECTLY ONTO THE EXISTING ALUMINUM WALKWAY CANOPY AS INDICATED. REFER TO DETAIL 1/A504.
- AVOID INSTALLING ANY GUTTER SEAM OR JOINT WITHIN 2-FEET (TYP.) OF INTERSECTING WALKWAYS (SIDEWALKS), ENTRANCES, DOORWAYS, ETC. LOCATIONS IDENTIFIED ON THESE PLANS MAY BE REPRESENTATIVE. CONTRACTOR SHALL FIELD VERIFY ALL LOCATIONS.
- WHERE GUTTERS ARE TO BE INSTALLED ALONG SLOPED RAKE EDGES, INSTALL NEW GALVALUME RAKE TRIM FLASHINGS AS INDICATED. SEE DETAIL 1/A504.
- WHERE INDICATED, EXTEND DOWNSPOUT DOWN FROM FASCIA PANELS BACK ONTO ADJACENT BRICK MASONRY COLUMN AS INDICATED. REFER TO DOWNSPOUT SCHEDULE, DETAIL 3/A502 FOR TYP. DOWNSPOUT PROFILE AT THIS CONDITION. PROVIDE AT LEAST ONE (1) MOCK-UP OF THIS REPRESENTATIVE CONDITION FOR REVIEW BY ENGINEER OF RECORD PRIOR TO INSTALLING DOWNSPOUTS AT SIMILAR CONDITIONS.
- WHERE DOWNPOUTS DEPOSIT RUNOFF TO LOWER SLOPED METAL ROOFING, FABRICATE BOTTOM OF DOWNSPOUT SO OUTLET DISCHARGES PARALLEL TO ROOF SLOPE (NOT PERPENDICULAR TO ROOF PANELS). REFER TO DOWNSPOUT SCHEDULE, DETAIL 3/A502 FOR TYP. DOWNSPOUT PROFILE AT THIS CONDITION.
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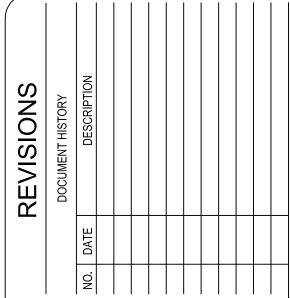
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GUTTER REPLACEMENT VCS Project No. 2247853
1860 N. CLYDE MORRIS BLVD.
DAYTONA BEACH, FL 32117

CAMPUS KEY PLAN

PLAN
NORTH

ARCH/ENGR OF RECORD
ALAN S. CRAIGO, P.E.

DESIGNED BY
AEA/EM

ISSUE DATE
10/14/2022


SHEET TITLE

HINSON

DAVID

ROOF PLAN BLDGS 5 AND 9

A104

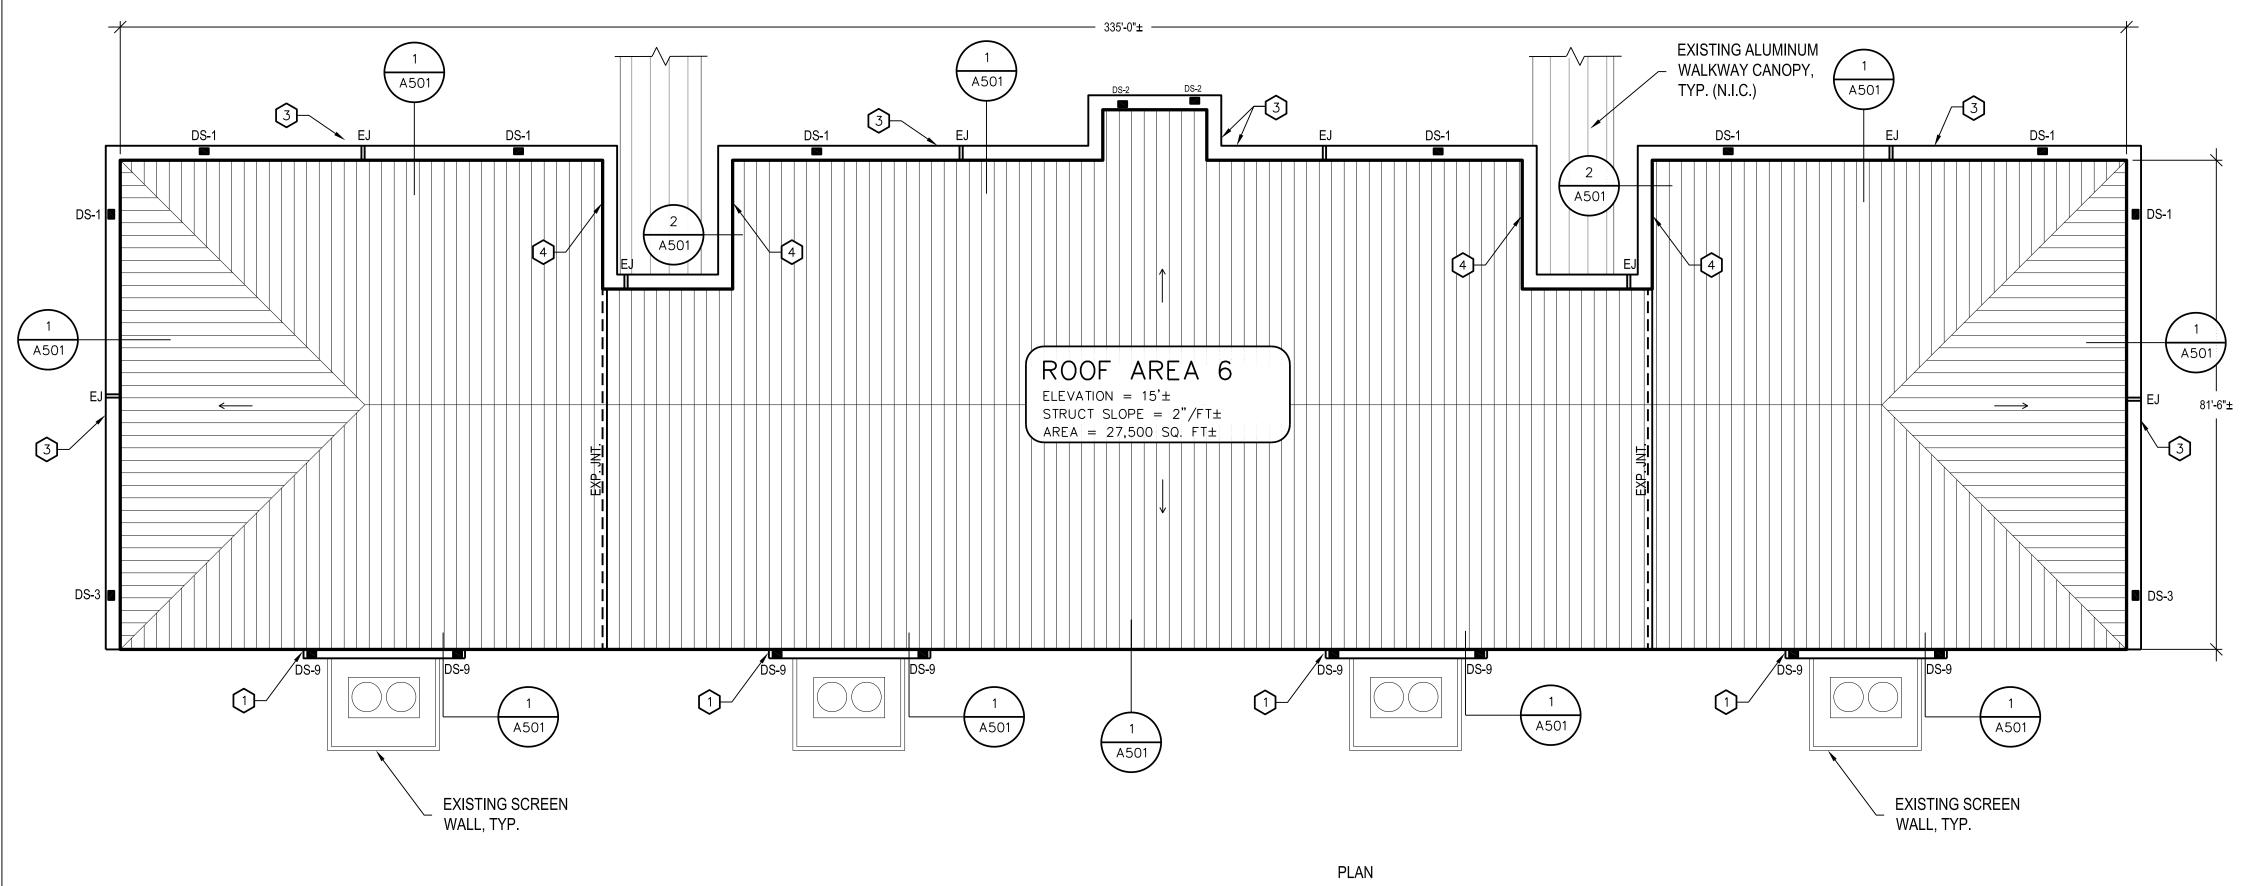

ROOF PLAN BLDG 6

SCALE: 1/16" = 1'-0"

GUTTER REPLACEMENT NOTES

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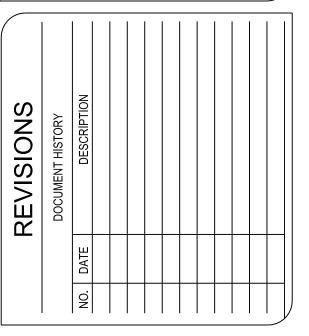
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CAMPUS KEY PLAN


PLAN

NORTH

	ARCH/ENGR OF RECORD
ENGR OF RECORD	
ALAN S. CRAIGO,	P.E.
DESIGNED BY	DRAWN BY
AEA/EM	FKL/EM
ISSUE DATE	AE PROJECT NUMBER
10/14/2022	678279
SHEET TITLE	
ROOF	PLAN

BLDG 6

MG NO. A 105

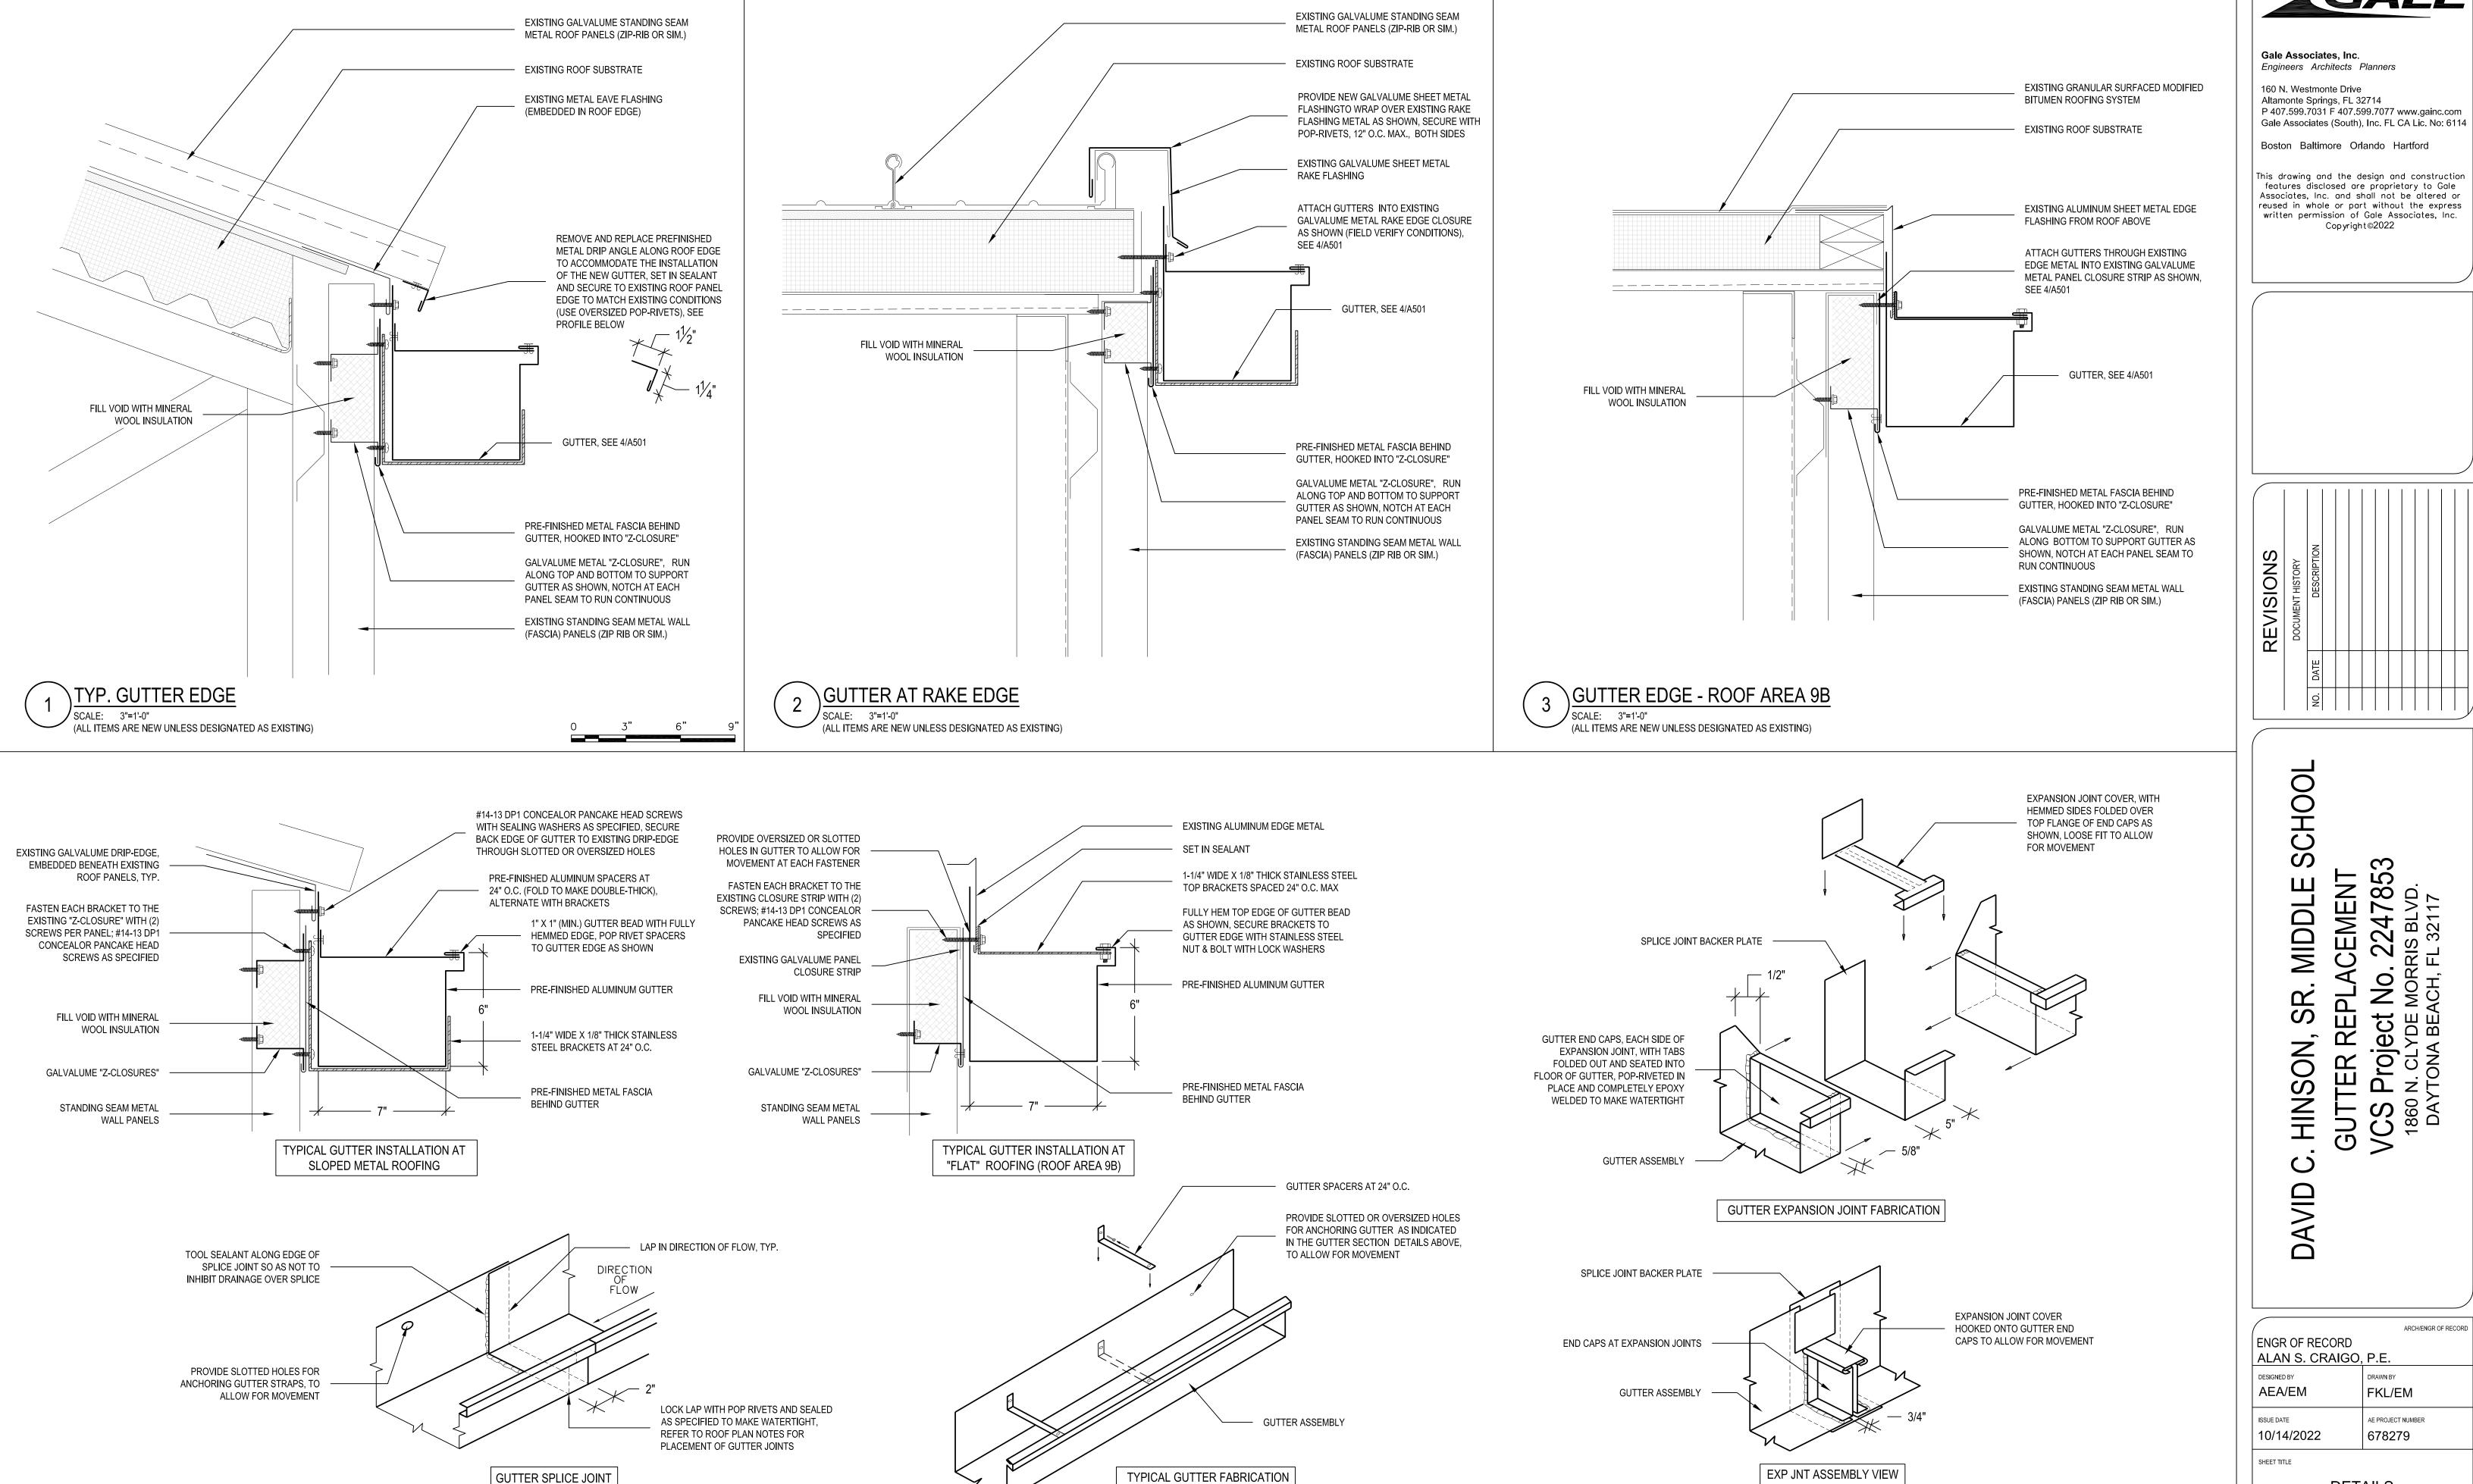

TYPICAL GUTTER FABRICATION

(ALL ITEMS ARE NEW UNLESS DESIGNATED AS EXISTING)

SCALE: N.T.S.

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PLACEMENT
No. 2247855
MORRIS BLVD.
ACH, FL 32117 REPL Proje GUTTER


ARCH/ENGR OF RECORD ENGR OF RECORD ALAN S. CRAIGO, P.E. FKL/EM AE PROJECT NUMBER 678279

DETAILS

A501

NOTE: LOCATE GUTTER EXPANSION


JOINTS AT 40-FT MAXIMUM SPACING.

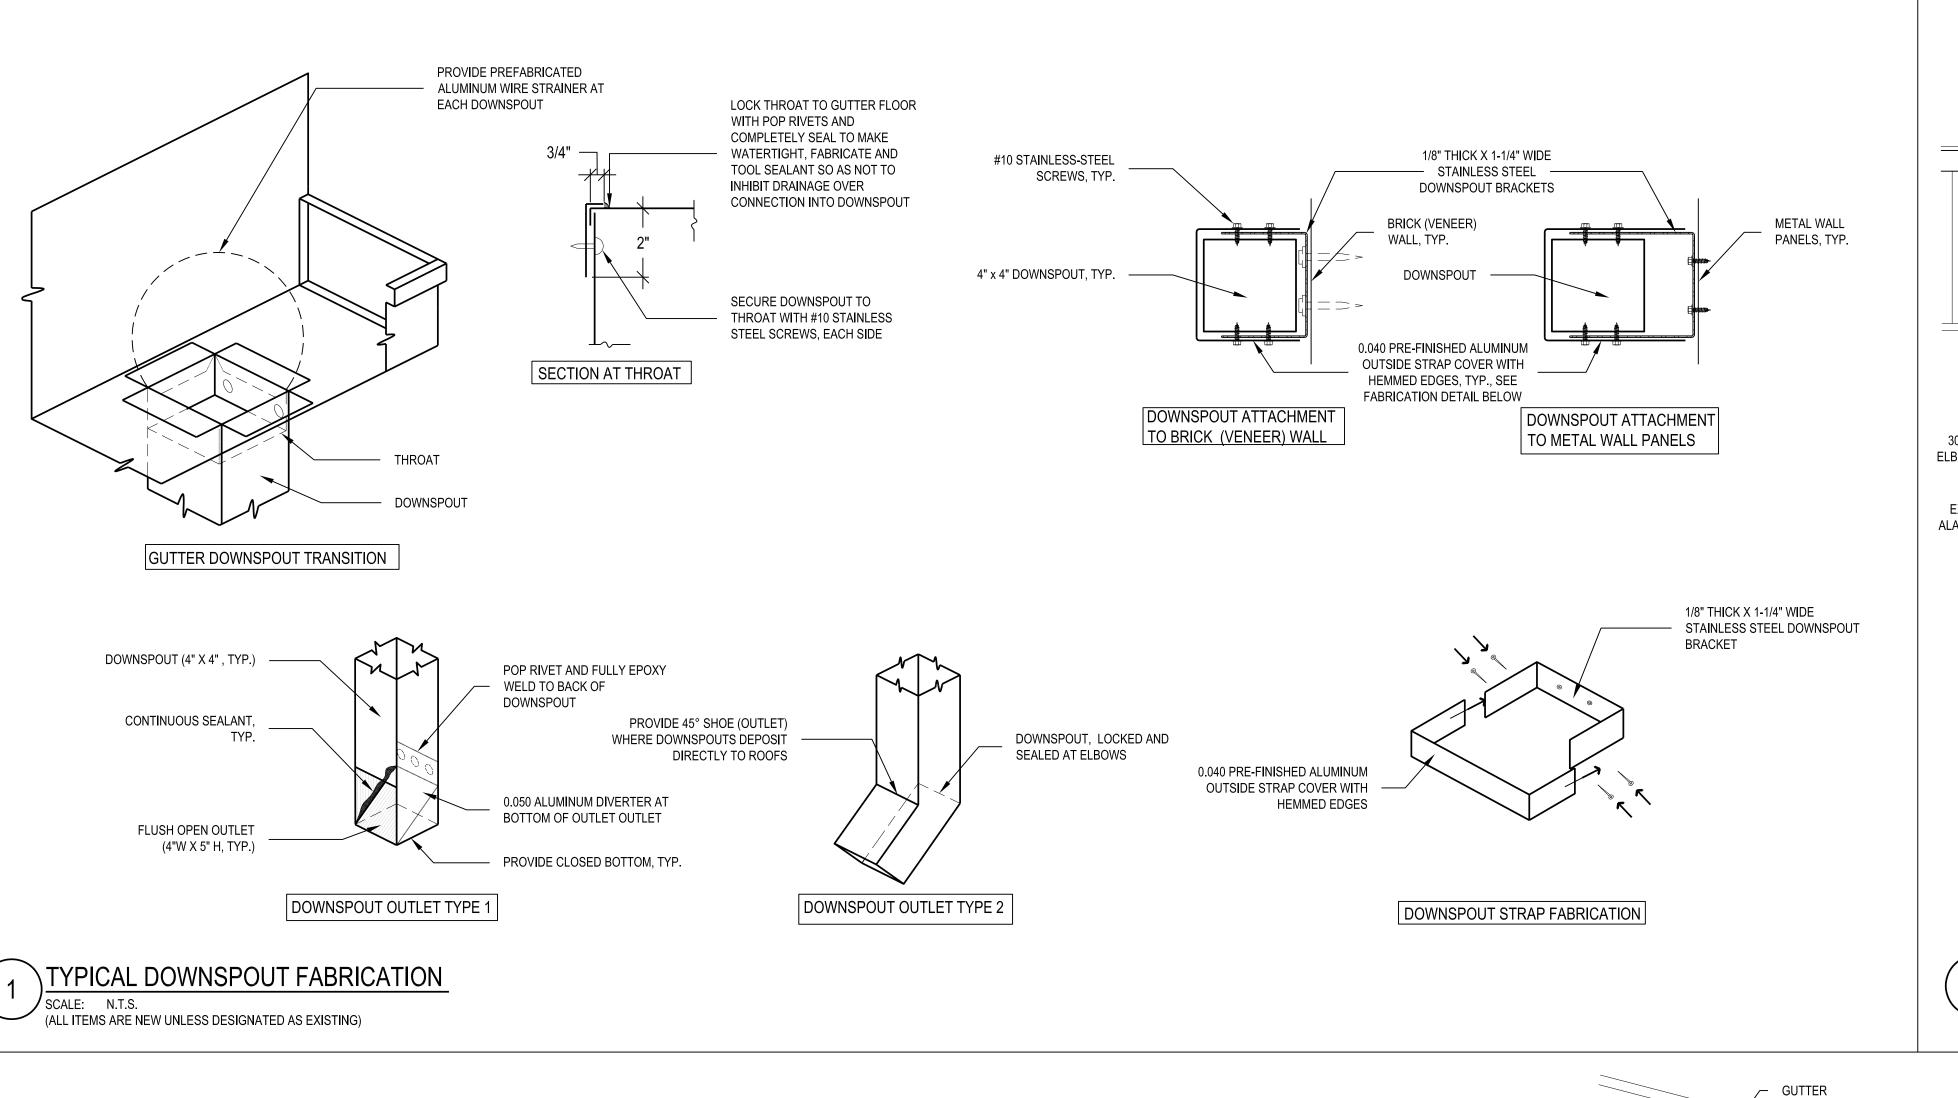


DOWNSPOUT TYPE AND OUTLET SCHEDULE

(ALL ITEMS ARE NEW UNLESS DESIGNATED AS EXISTING)

SCALE: N.T.S.

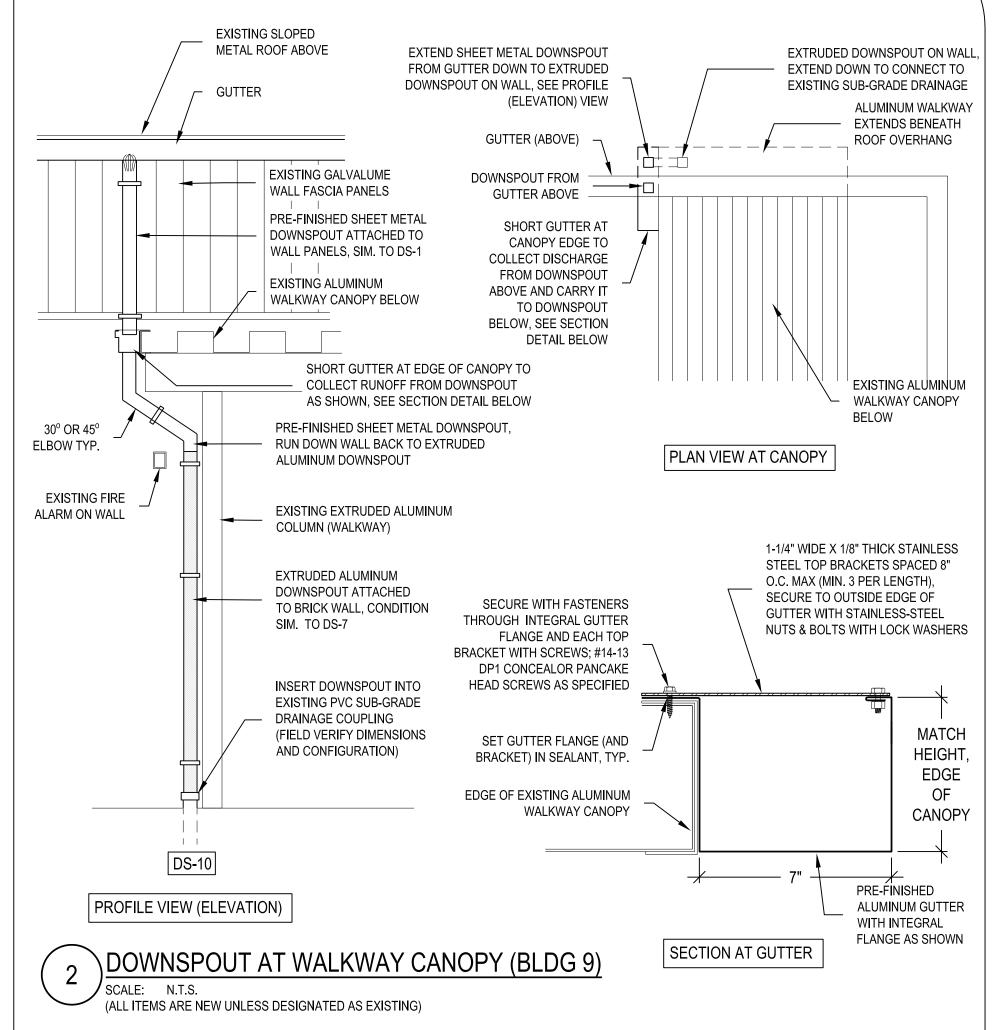

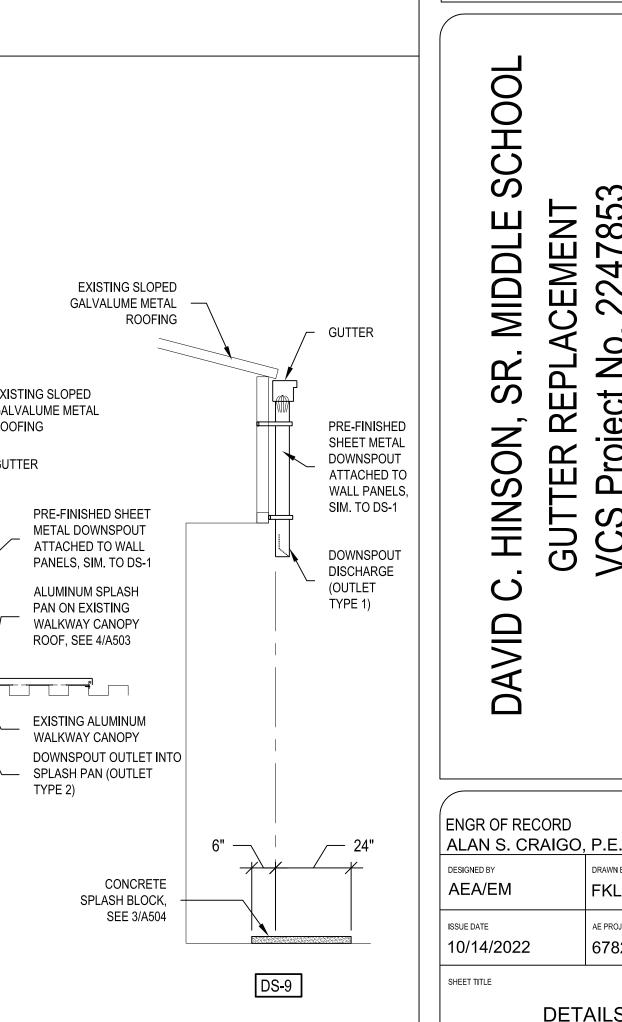

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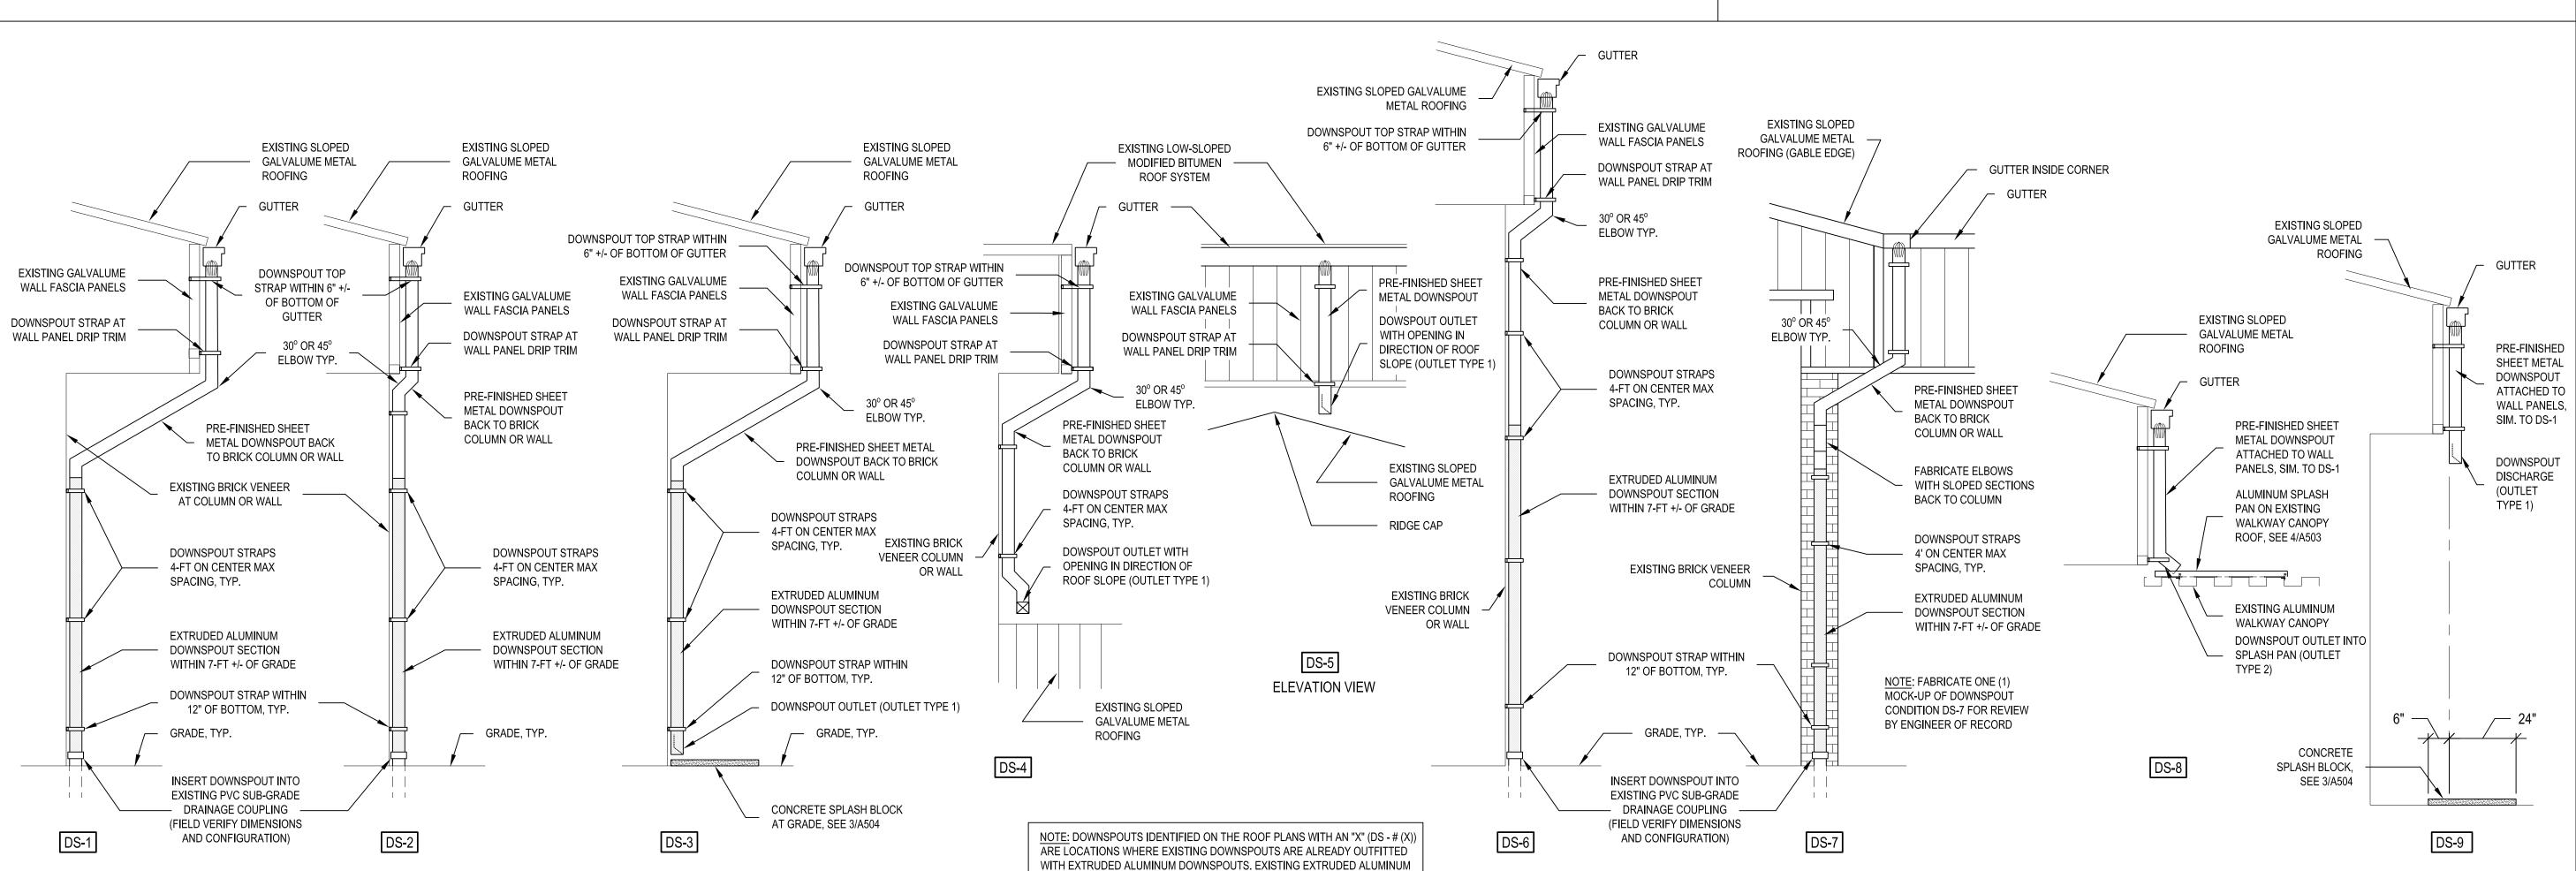
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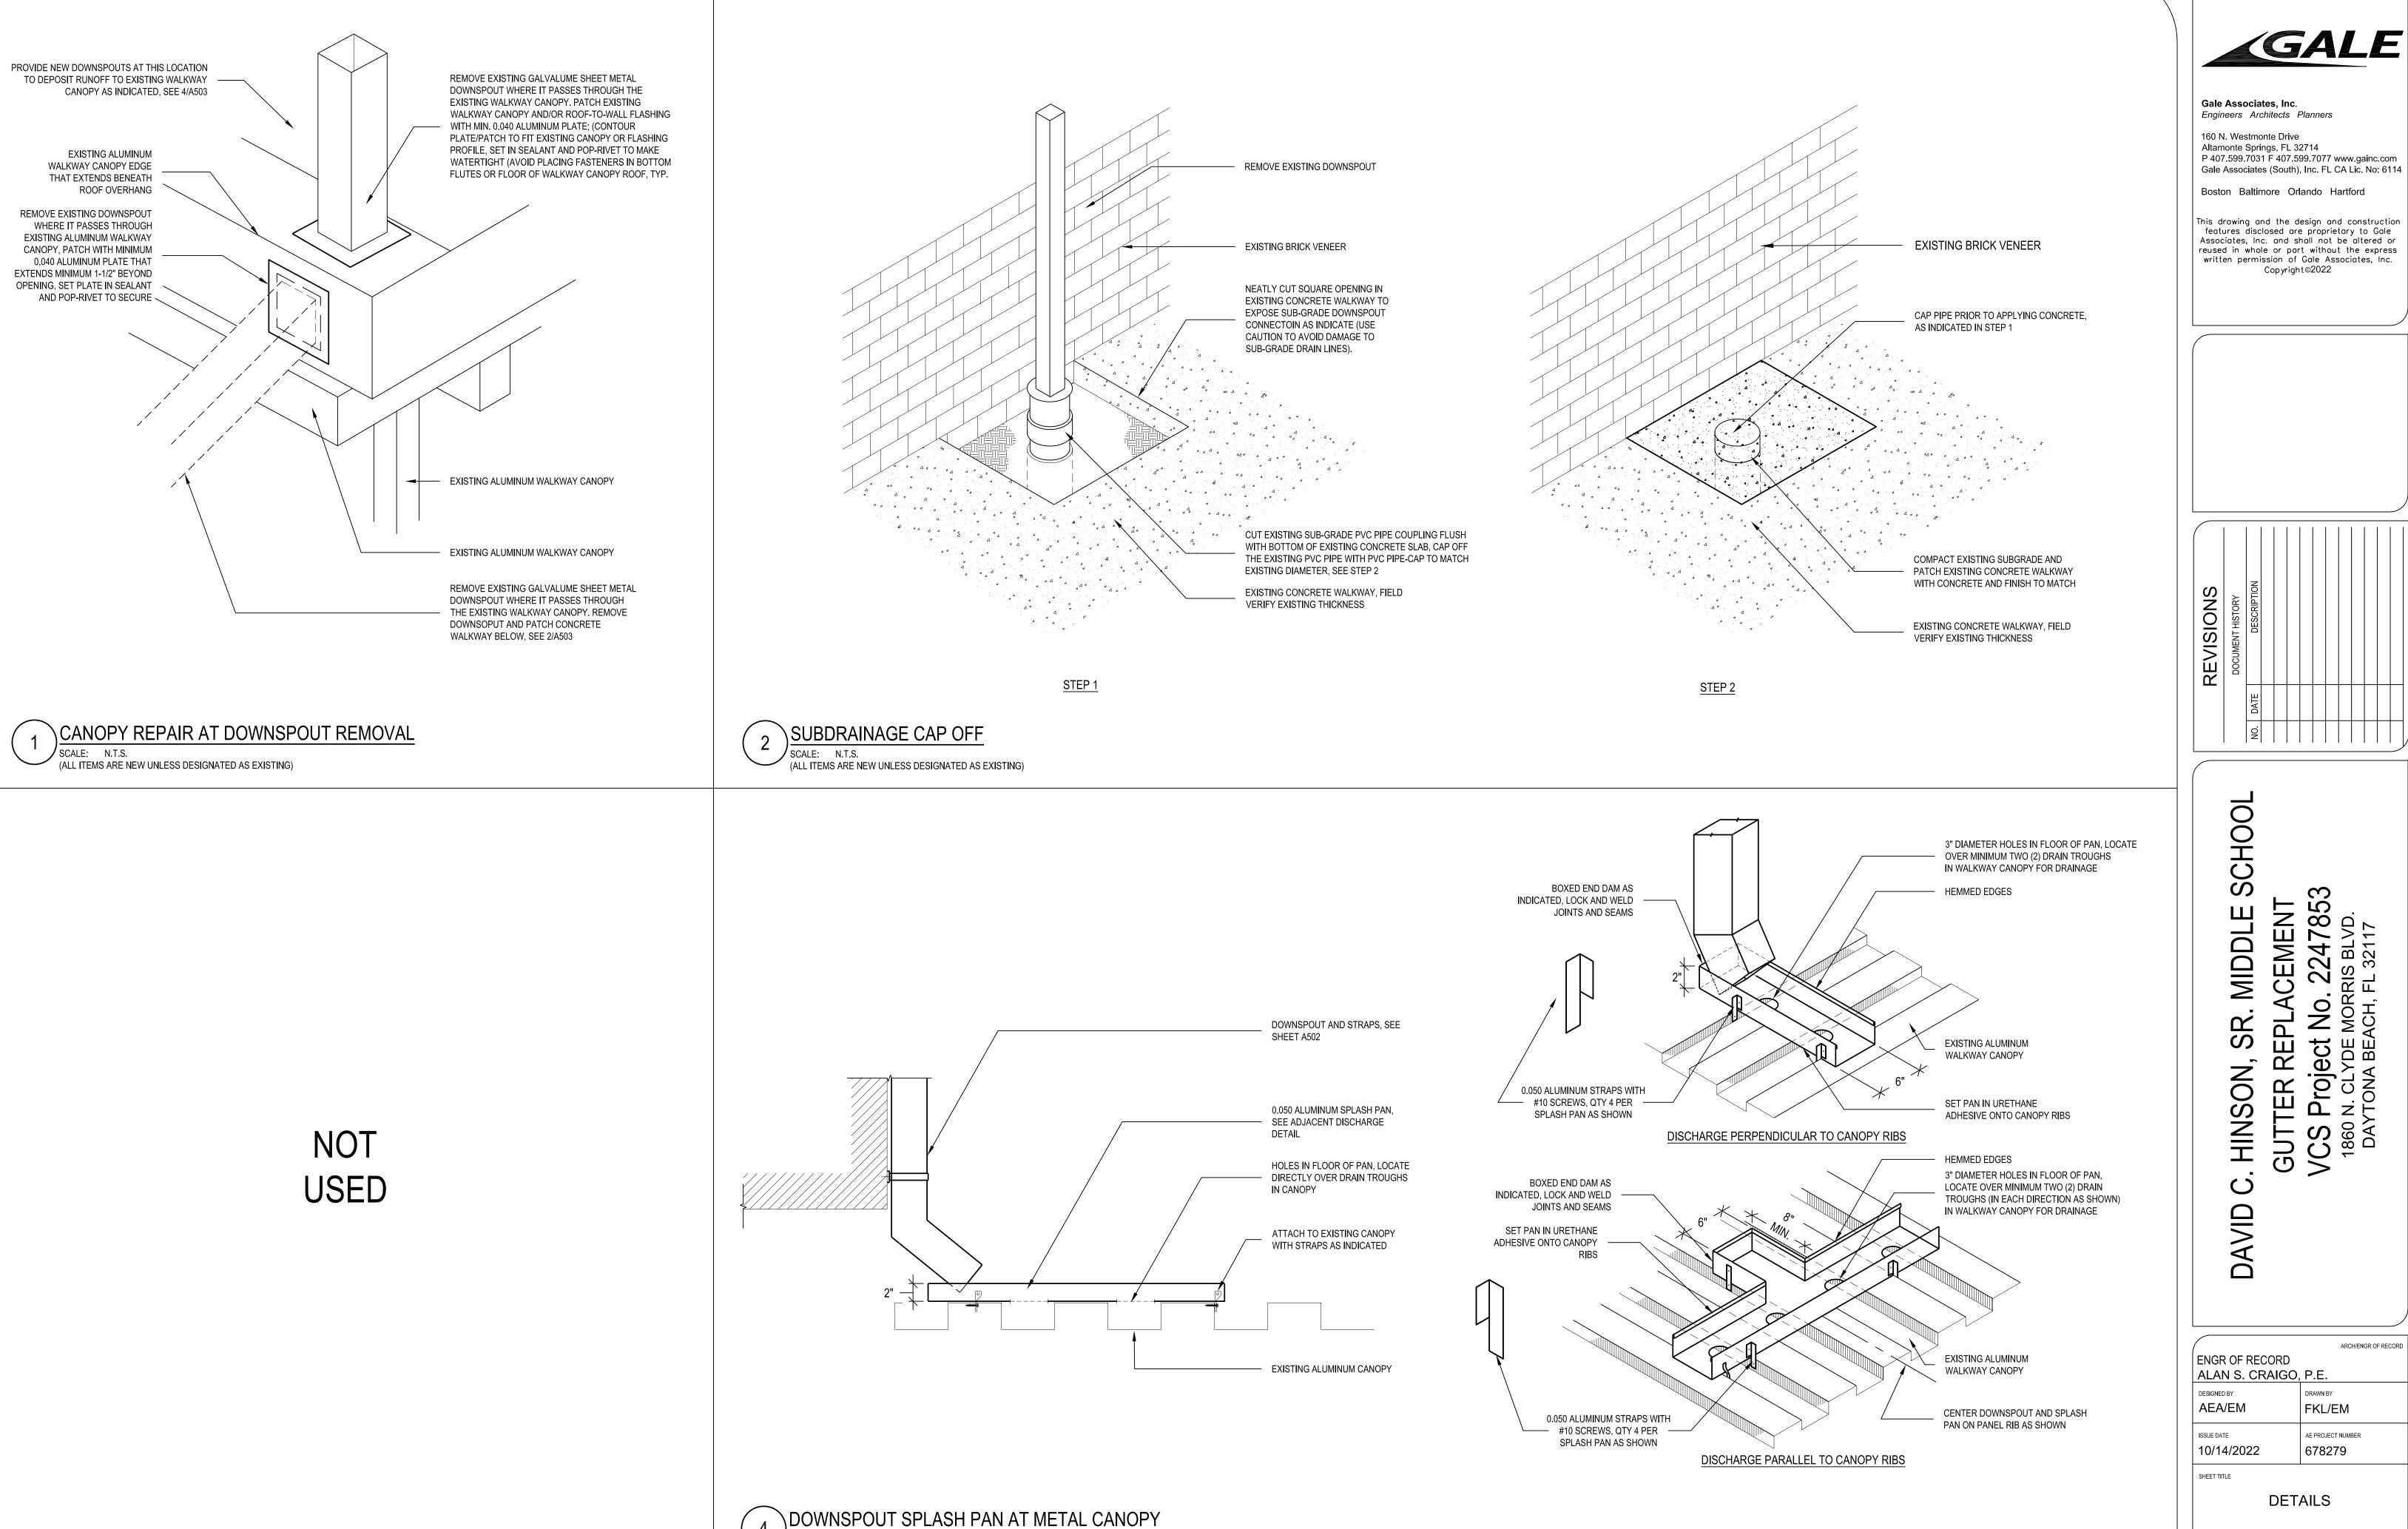
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DOWNSPOUTS SECTIONS MAY BE CLEANED, ADJUSTED AND RE-USED IF IN

GOOD CONDITION. REFER TO SPECIFICATION SECTION 012200 - UNIT PRICES

FOR ADDITIONAL INFORMATION.



(ALL ITEMS ARE NEW UNLESS DESIGNATED AS EXISTING)



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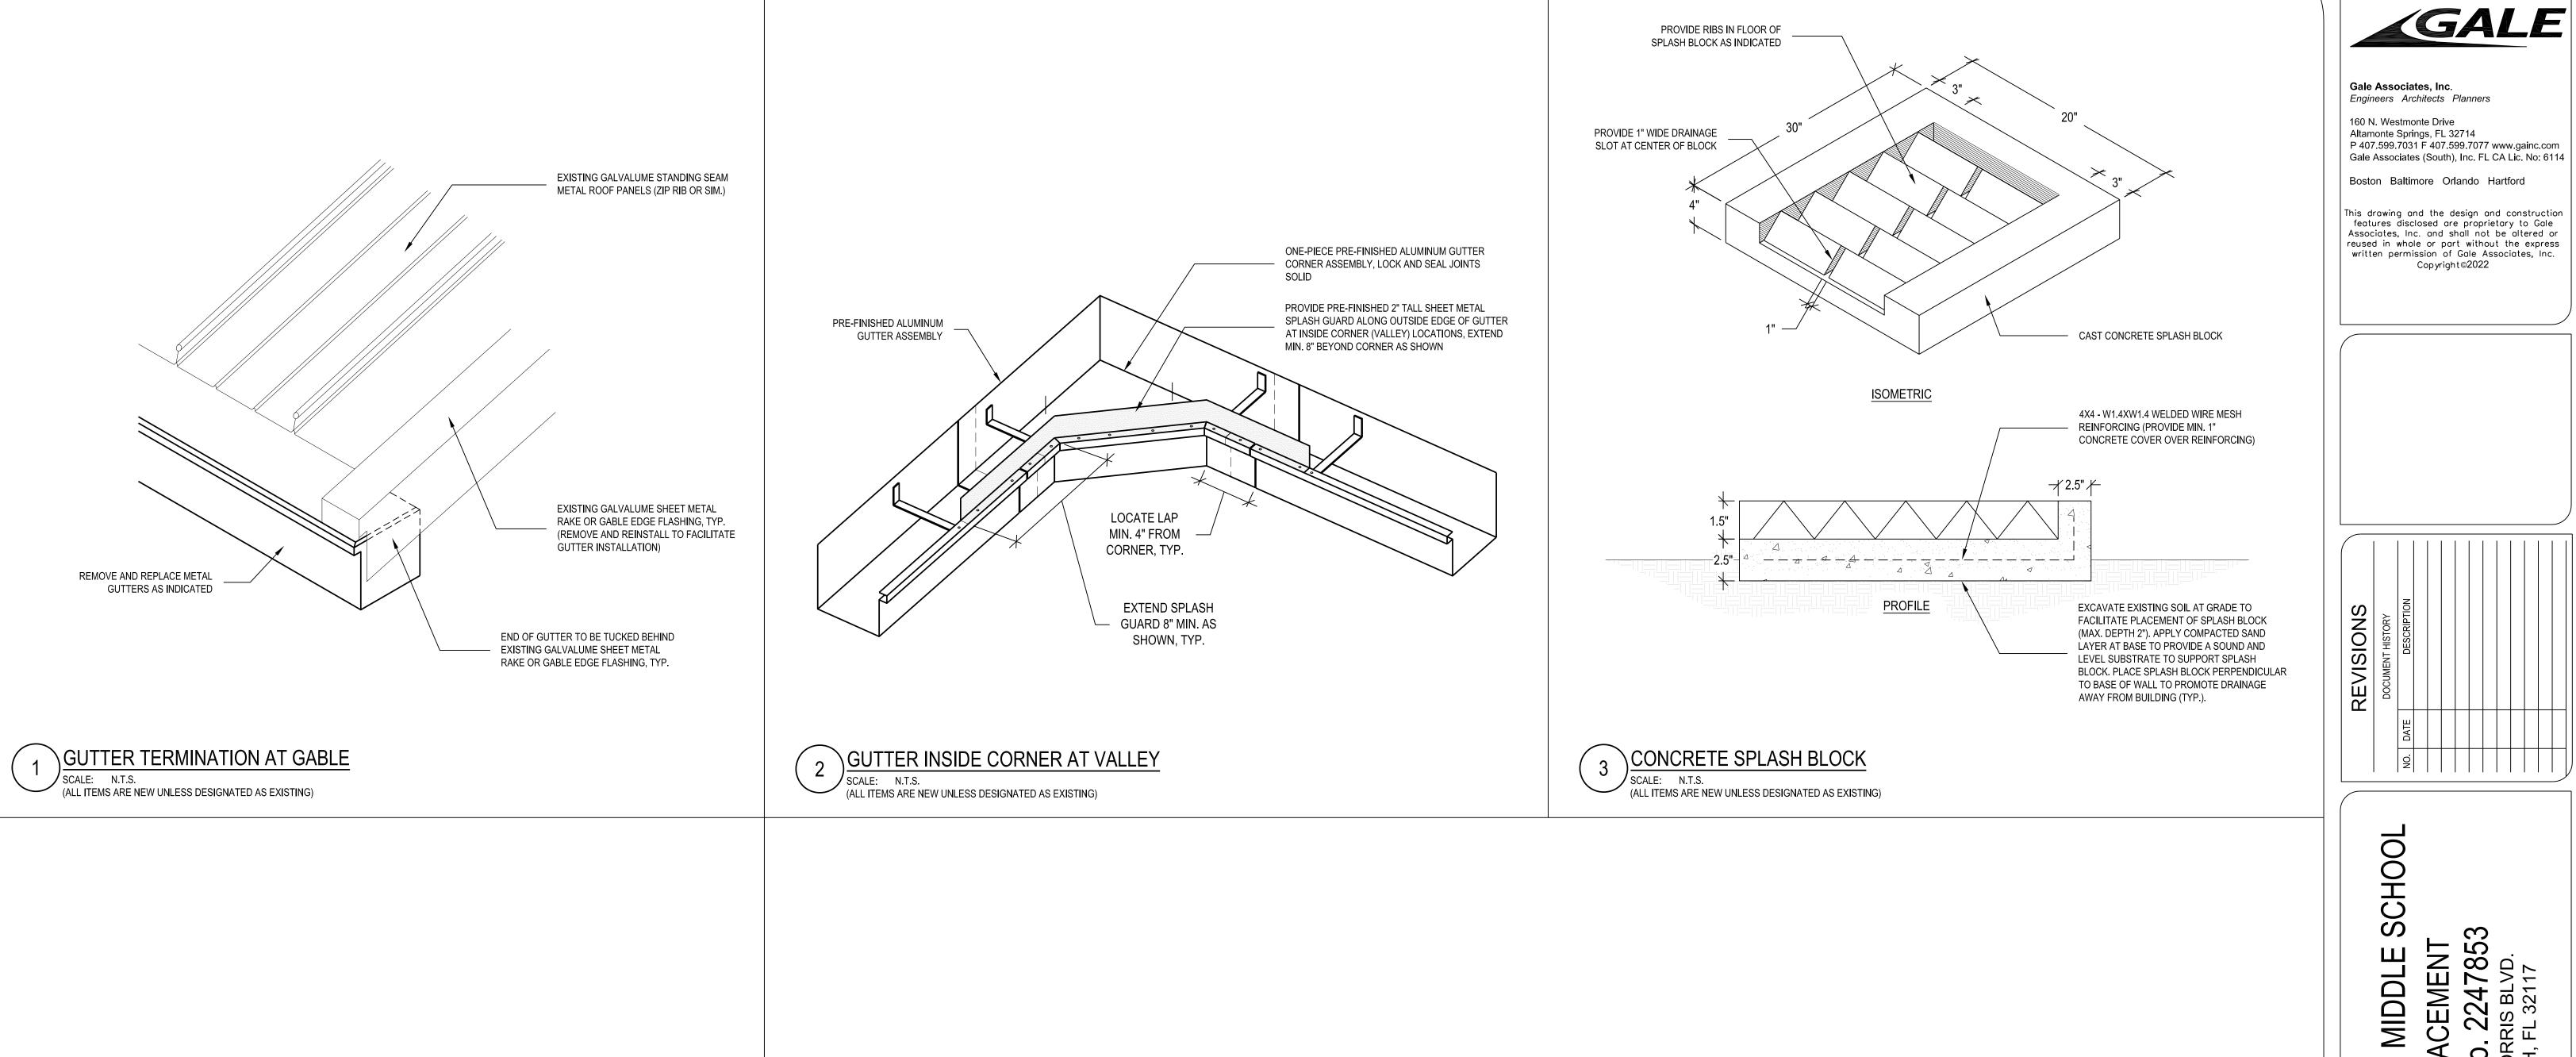
SCHO ACEMENT O. 2247855 DRRIS BLVD. H, FL 32117 MIDDLE SR REPL HINSON, GUTTER

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ENGR OF RECORD ALAN S. CRAIGO, P.E.		
DRAWN BY FKL/EM		
AE PROJECT NUMBER 678279		

DETAILS

DAVID

A503



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DAYTONA BEACH, FL 32117 SR. MIDDLE DAVID C. HINSON,

ENGR OF RECORD ALAN S. CRAIGO, P.E. FKL/EM AEA/EM AE PROJECT NUMBER 10/14/2022

A504

DETAILS