

THE SCHOOL BOARD OF VOLUSIA

COUNTY FLORIDA

200 North Clara Avenue

DeLand, Florida 32720

SEABREEZE HIGH SCHOOL REROOF MEDIA CENTER

VCS Project NO. 194737

2700 NORTH OLEANDER AVENUE DAYTONA BEACH, FL 32118

SCHOOL BOARD **MEMBERS**

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DR. CARMEN J. BALGOBIN SUPERINTENDENT

DESCRIPTION OF WORK

REMOVE AND REPLACE LOW-SLOPE ROOFING SYSTEM ON MEDIA CENTER. CLEAN AND COAT CONCRETE FOLDED PLATE

Architect's Statement of Compliance

To the best of my knowledge, these drawings and the project manual are complete and comply with the Florida Building Code.

BUILDING DATA

C. OCCUPANCY TYPE TYPE V (UNPROTECTED)

D. CONSTRUCTION TYPE

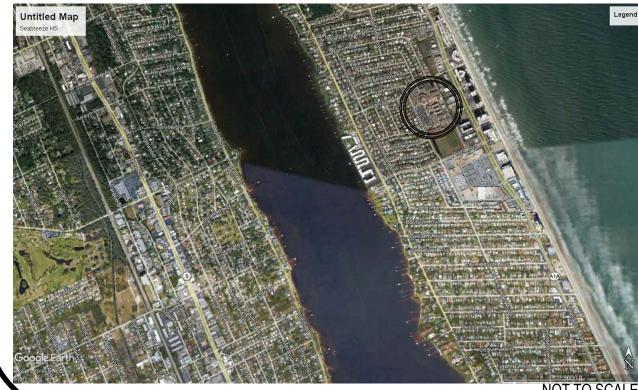
OCCUPANT LOAD

E. RISK CATEGORY

F. AUTOMATIC SPRINKLER **EXISTING** 14,500 SF G. BUILDING AREA

H. BUILDING HEIGHT

LOCATION MAP



ENGINEERS & CONSULTANTS

1675 LEE ROAD WINTER PARK, FL 32789 JAMES E. SAIZAN, R.A.

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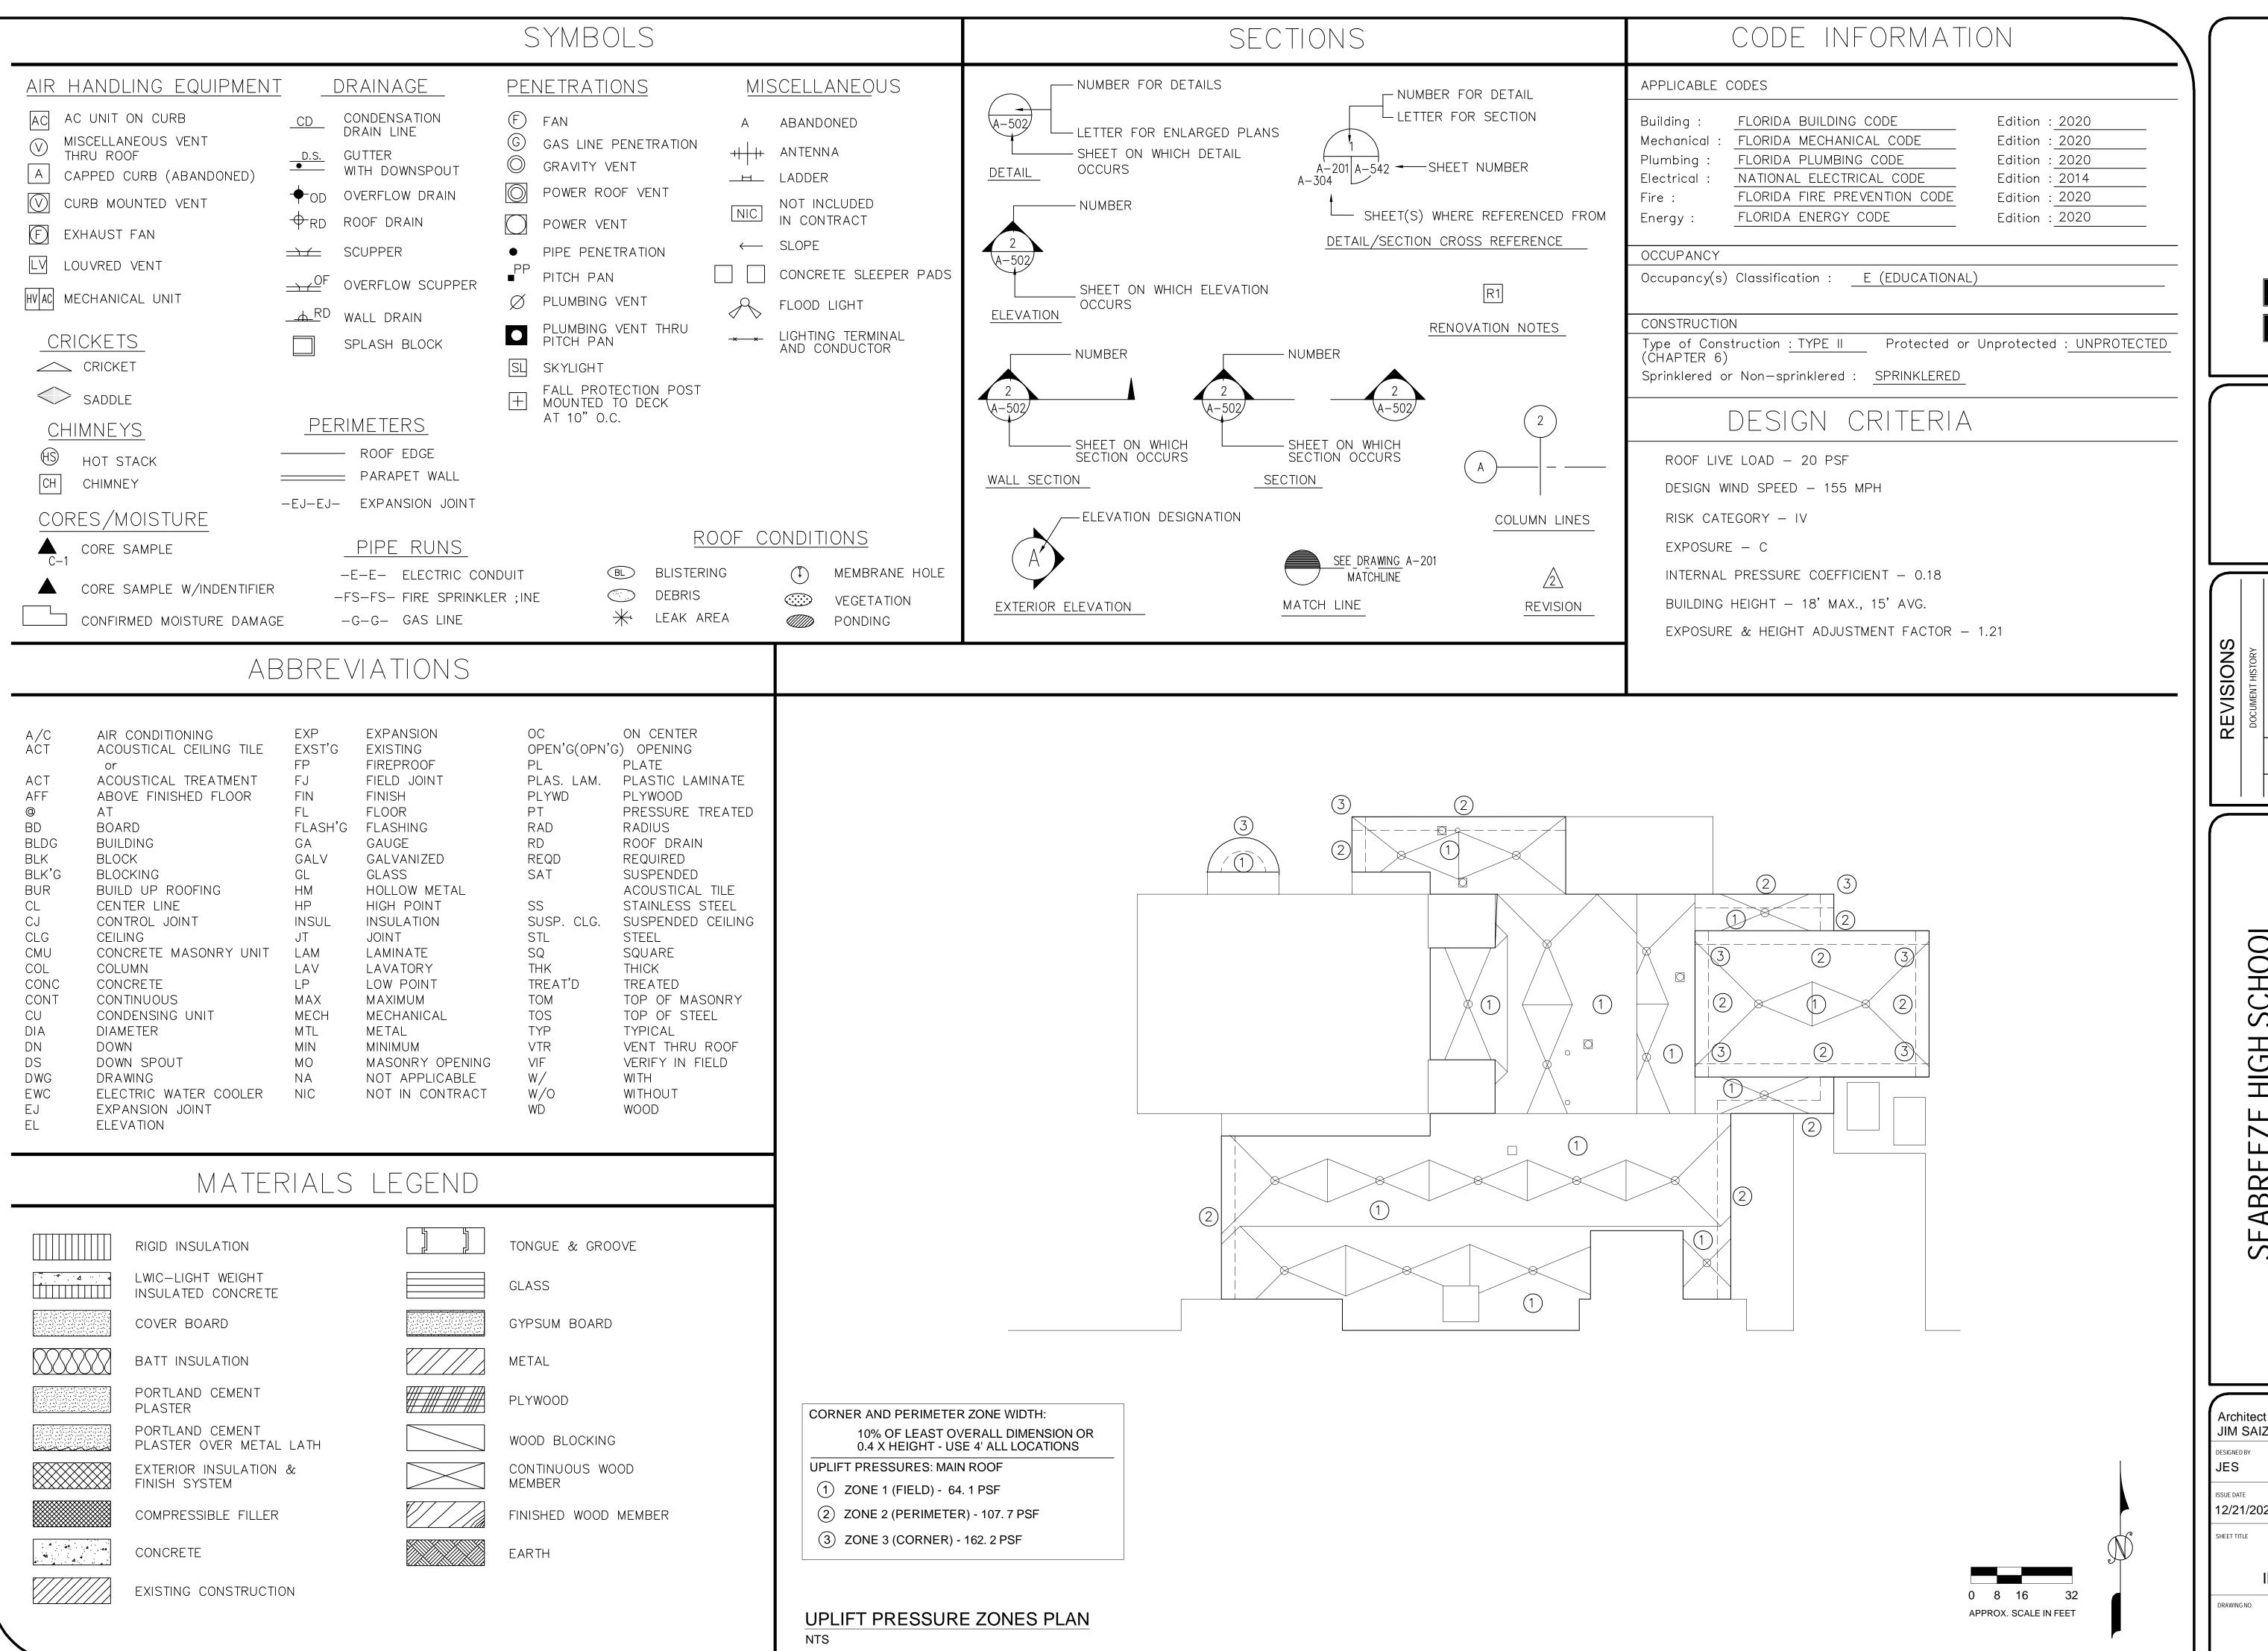
REROOF MEDIA (VCS Project NO. REROOF

Architect JIM SAIZAN	ARCH/ENGR OF RECORD							
DESIGNED BY	DRAWN BY							
JES	JMP							
ISSUE DATE	AE PROJECT NUMBER							
12/21/2022	F9196119							
SHEET TITLE								
COVER								
DRAWING NO.								
G-001								

ROOF DETAILS ROOF DETAILS

ROOF DETAILS

CONSTRUCTION DOCUMENTS - 1/6/2023



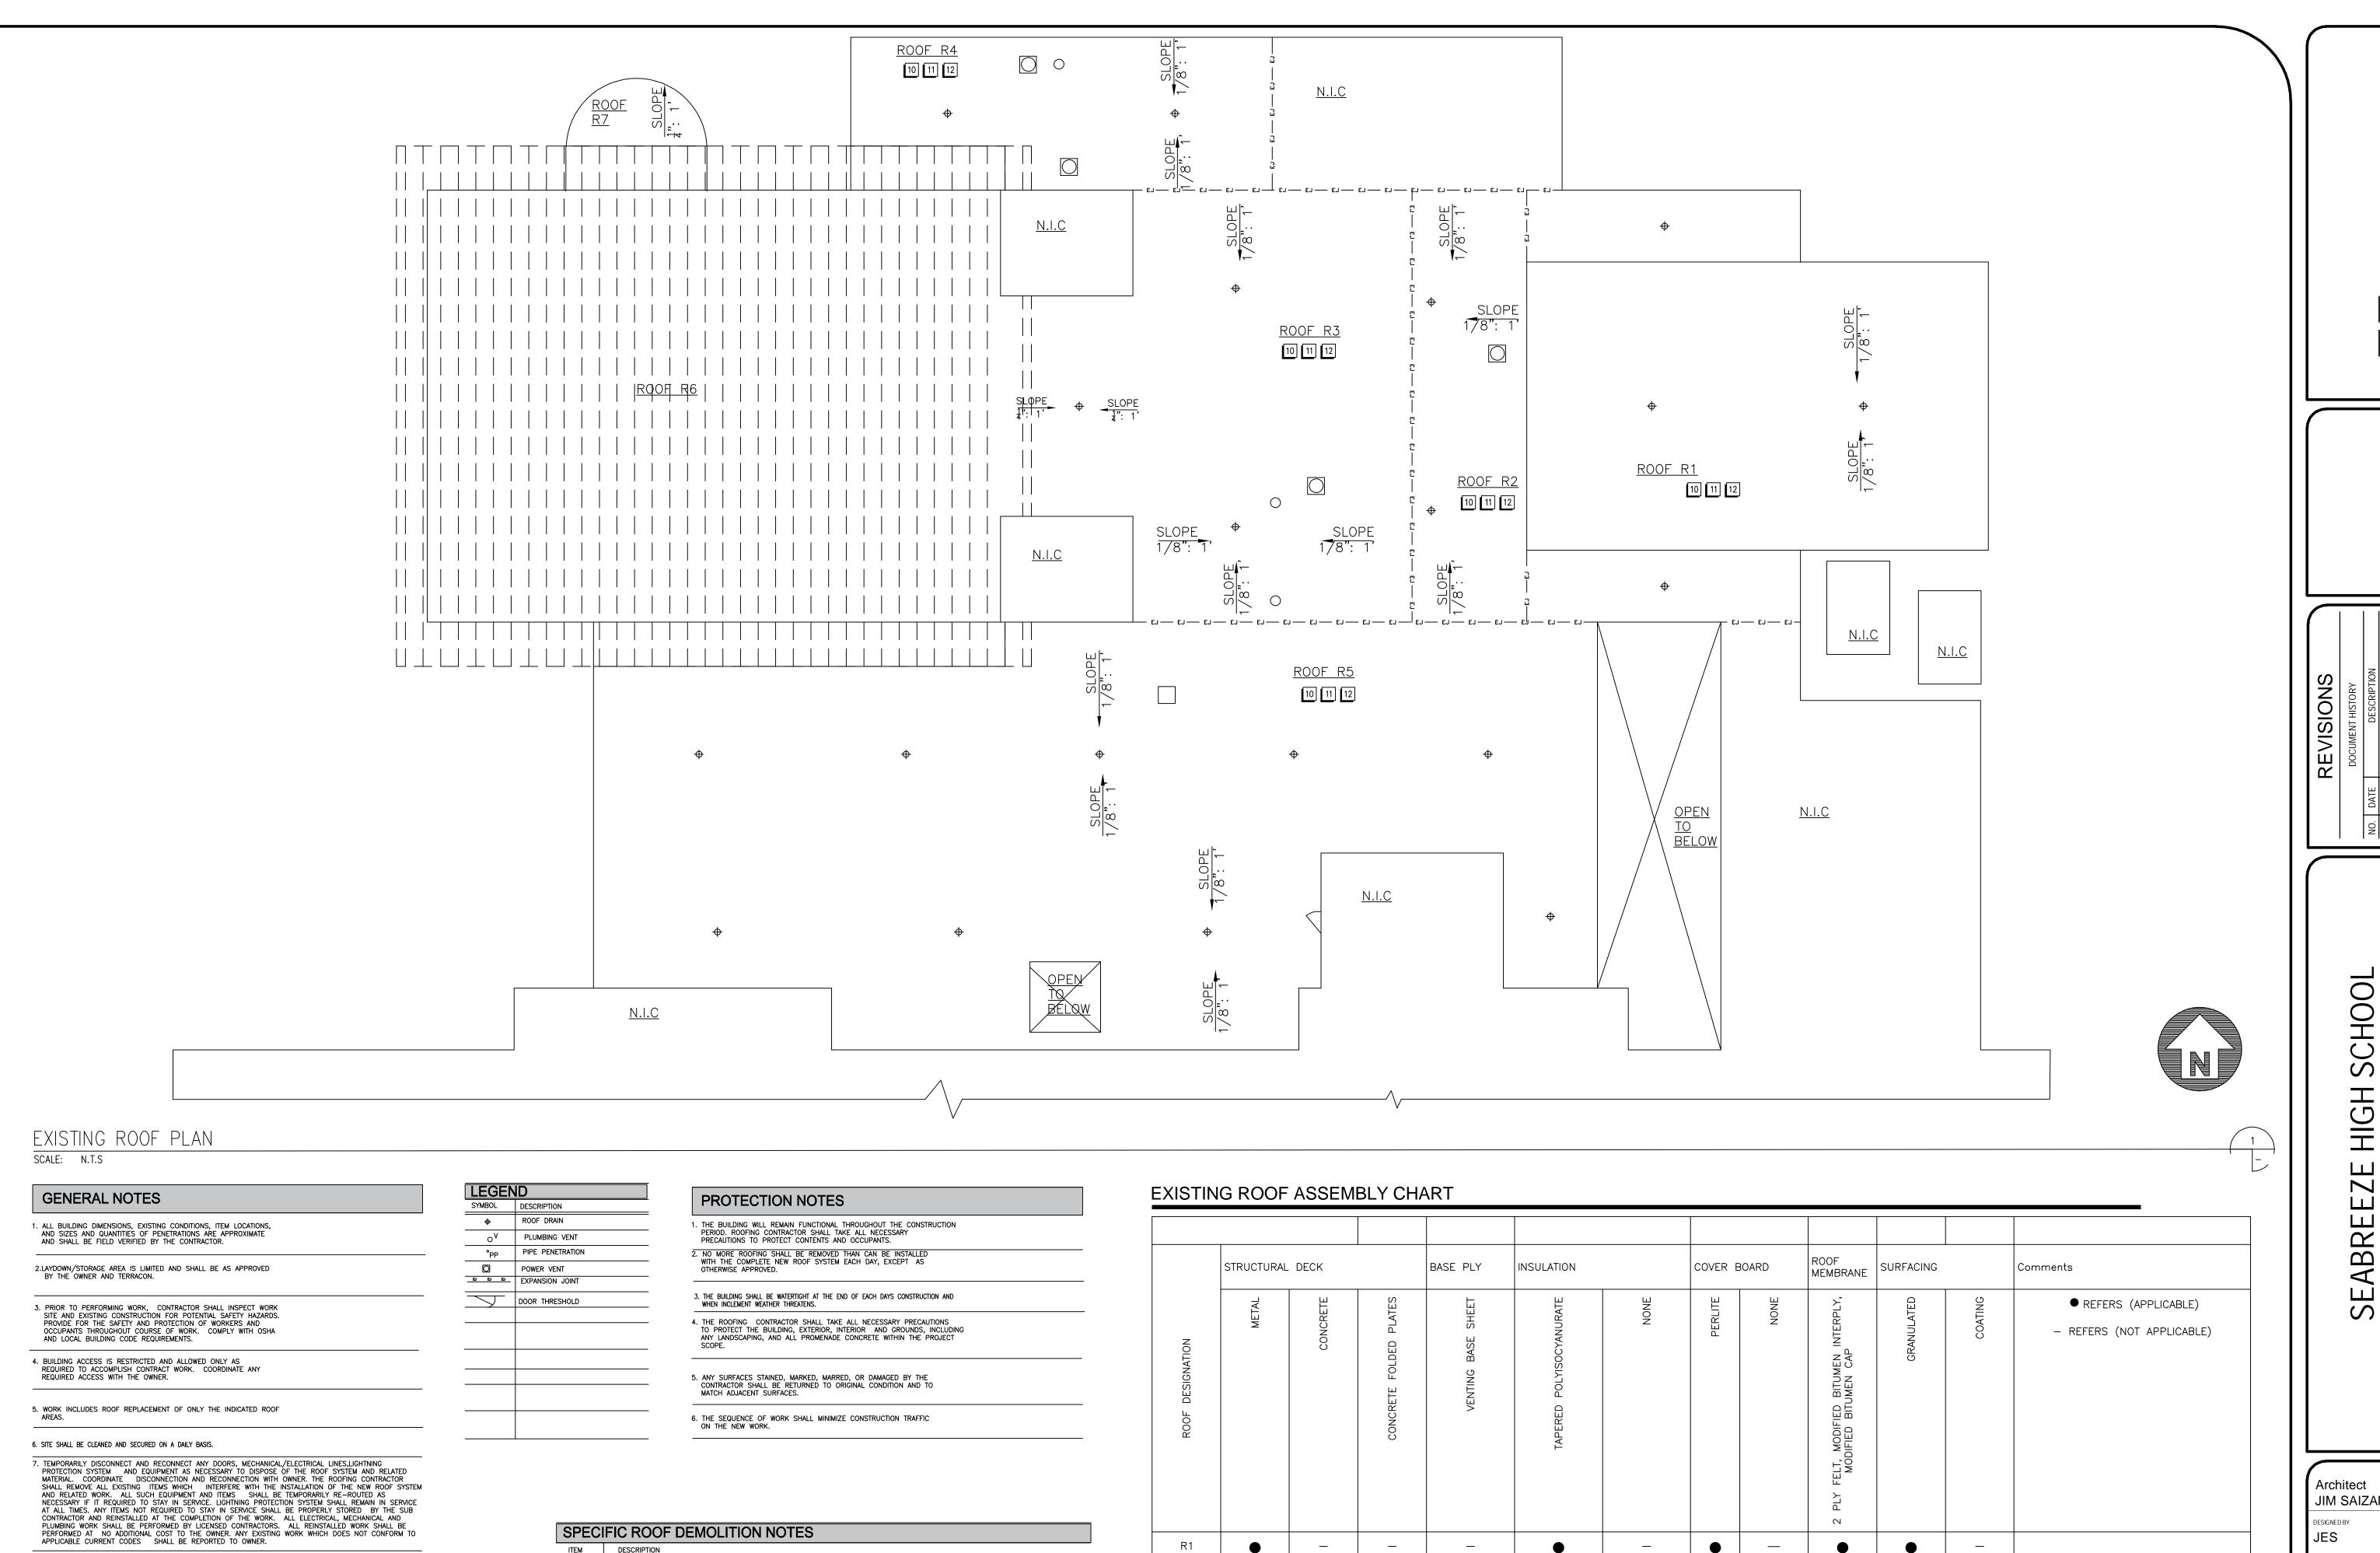
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ARCH/ENGR OF RECOF JIM SAIZAN XXX AE PROJECT NUMBER 12/21/2022 F9196119 LEGEND & **GENERAL INFORMATION**

G-002



R6

SPECIFIC ROOF DEMOLITION NOTES

PREPARE EXISTING SURFACE TO RECEIVE NEW REINFORCED COATING SYSTEM PER ROOF COATING MANUFACTURER REQUIREMENTS.

ITEM

ARCH/ENGR OF RECO Architect JIM SAIZAN DESIGNED BY DRAWN BY JES JMP ISSUE DATE AE PROJECT NUMBER 12/21/2022 F9196119 SHEET TITLE ROOF DEMOLITION PLAN

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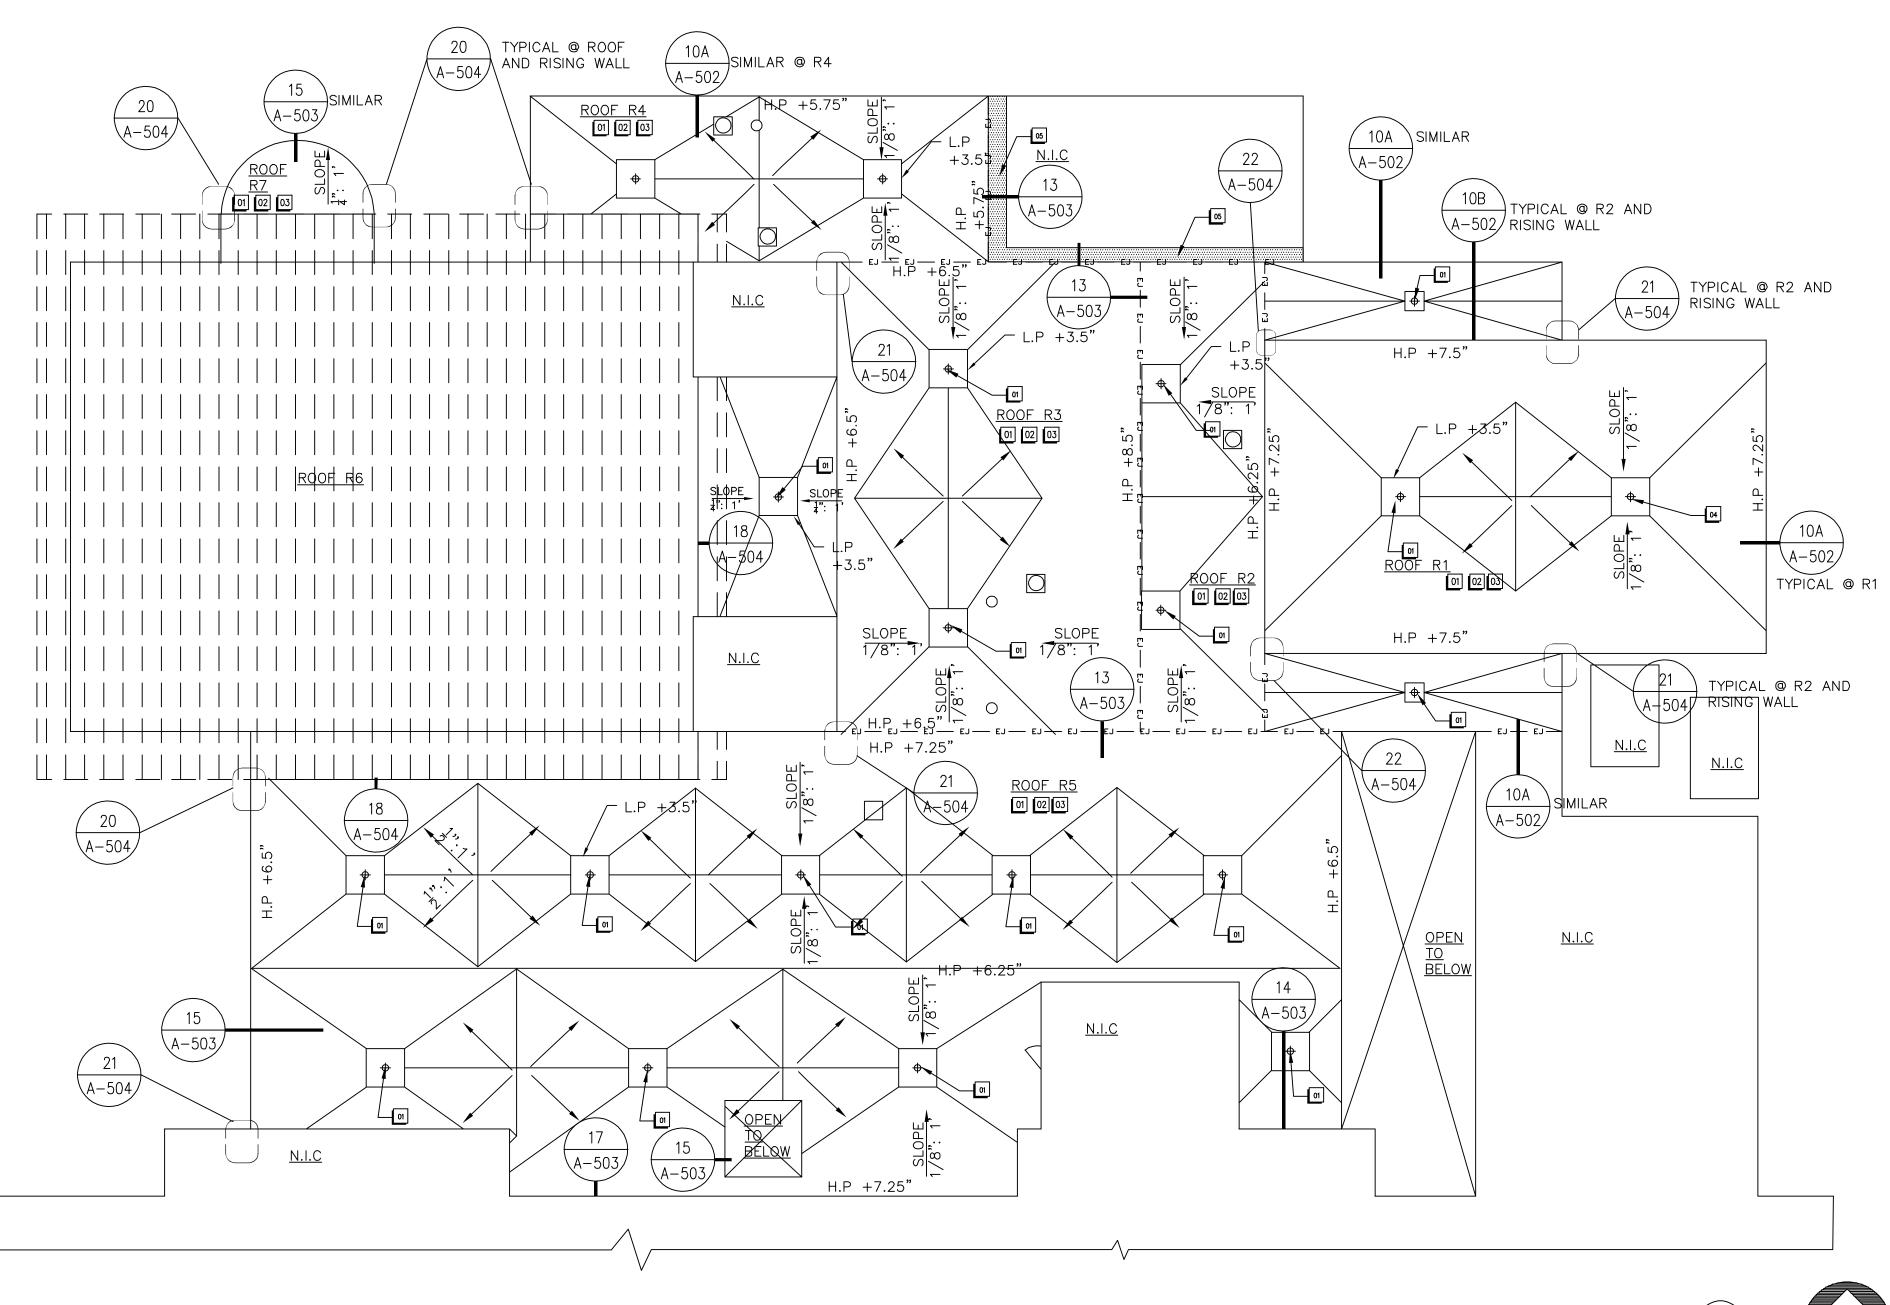
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2700 NORTH C DAYTONA

5. ANY SURFACES STAINED, MARKED, MARRED, OR DAMAGED BY THE CONTRACTOR SHALL BE RETURNED TO ORIGINAL CONDITION AND TO MATCH ADJACENT SURFACES. 6. THE SEQUENCE OF WORK SHALL MINIMIZE CONSTRUCTION TRAFFIC ON THE NEW WORK.	ROOF DESIGNATION			CONCRETE FOLDE	VENTING BA	TAPERED POLYISOC				PLY FELT, MODIFIED BITUMEN CAP	GR		
CIFIC ROOF DEMOLITION NOTES					+					2			
DESCRIPTION	R1	•	_	_	_	•	_			•	•	_	
REMOVE AND DISPOSE OF EXISTING ROOF MEMBRANE, COVERBOARD, INSULATION, ASSOCIATED FLASHINGS, SHEET METAL FLASHINGS. PREPARE STRUCTURAL DECK AS REQUIRED TO RECEIVE NEW ROOF ASSEMBLY.	R2	•	_	_	_	•	_	•	_	•	•	_	
REMOVE AND DISPOSE OF EXISTING ROOF DRAIN ASSEMBLY. INSTALL NEW ROOF DRAIN ASSEMBLY.	R3	_	•	_	•	_	_		_	•	•	_	
TEMPORARILY DISCONNECT AND RECONNECT ANY MECHANICAL/ELECTRICAL LINES AND EQUIPMENT AS NECESSARY TO DISPOSE OF THE ROOF SYSTEM AND RELATED MATERIAL. COORDINATE DISCONNECTION AND RECONNECTION WITH OWNER. THE ROOFING CONTRACTOR SHALL REMOVE ALL EXISTING ITEMS WHICH INTERFERE WITH THE INSTALLATION OF THE NEW ROOF SYSTEM	R4	•	_	_	_	•	_	•	_	•	•	_	
AND RELATED WORK. ALL SUCH EQUIPMENT AND ITEMS SHALL BE TEMPORARILY RE-ROUTED AS NECESSARY IF IT REQUIRED TO STAY IN SERVICE. ANY ITEMS NOT REQUIRED TO STAY IN SERVICE SHALL BE PROPERLY STORED BY THE SUB CONTRACTOR AND REINSTALLED AT THE COMPLETION OF THE WORK. ALL ELECTRICAL, MECHANICAL AND PLUMBING WORK SHALL BE PERFORMED BY LICENSED CONTRACTORS. ALL REINSTALLED WORK SHALL BE PERFORMED AT NO ADDITIONAL COST TO THE OWNER. ANY EXISTING WORK WHICH	R5	•	_	_	_	•	_	•	_	•	•	_	
DOES NOT CONFORM TO APPLICABLE CURRENT CODES SHALL BE REPORTED TO OWNER.	R6	_	_		_	_		_		_	_		



NEW ROOF PLAN SCALE: N.T.S

GENERAL CONSTRUCTION NOTES

- THE ROOFING CONTRACTOR SHALL VERIFY ALL CONDITIONS IN THE FIELD. THIS SHALL INCLUDE VERIFYING THE EXACT LOCATIONS, DIMENSIONS AND QUANTITIES OF ALL ROOFTOP EQUIPMENT AND APPURTENANCES WHICH INCLUDING, BUT IS NOT LIMITED TO VENT PIPES, DRAINS, FLUE PIPES, HOT STACK CURBS, BASE FLASHING AND ALL OTHER PENETRATIONS AND WORK ASSOCIATED WITH THIS ROOFING PROJECT. ROOFING SUB CONTRACTOR SHALL NOTIFY TERRACON, IN WRITING, OF ALL CONDITIONS WHICH ARE IN VARIANCE WITH THE CONDITIONS DOCUMENTED HEREIN PRIOR TO SUBMITTING A BID. AFTER AWARD NO ADDITIONAL COSTS TO OWNER WILL BE ACCEPTED.
- THE BUILDING MAY BE FULL OR PARTIALLY OCCUPIED; ROOFING CONTRACTOR IS SOLELY RESPONSIBLE FOR ALL MEANS AND METHODS OF CONSTRUCTION.
- ROOFING CONTRACTOR SHALL PROTECT ALL EXISTING CONSTRUCTION TO REMAIN, INCLUDING GROUNDS, EXTERIOR SURFACES AND THE INTERIOR OF THE BUILDING. DAMAGE CONDITION BY THE SUB CONTRACTOR SHALL BE REPAIRED AT NO ADDITIONAL COST TO THE OWNER. ALL REPAIR WORK MUST CONFORM TO THE ORIGINAL CONDITIONS AND SATISFY TO THE OWNER.
- ALL WORK SHALL BE PERFORMED IN STRICT ACCORDANCE WITH ALL CODES AND AUTHORITIES HAVING JURISDICTION OVER THIS PROJECT.
- ALL DETAILS INDICATE MINIMUM INSTALLATION REQUIREMENTS. IF THE MANUFACTURER'S STANDARD DETAILS ARE MORE STRINGENT, IN THE OPINION OF TERRACON, THEY SHALL GOVERN. IF THE DETAILS SHOWN ARE MORE STRINGENT THAN THE MANUFACTURER'S STANDARD DETAILS, IN THE OPINION OF THE TERRACON, THE DETAILS SHOWN SHALL GOVERN, REGARDLESS OF THE MANUFACTURER'S WILLINGNESS TO WARRANT / GUARANTY THE LESSER DETAIL. BY SUBMITTING A BID FOR THIS PROJECT, IT IS UNDERSTOOD THAT THE ROOFING CONTRACTOR AND MANUFACTURER AGREE TO WARRANTY / GUARANTY THE DETAILS SHOWN. TERRACON MAY, BUT IS NOT OBLIGATED TO, ACCEPT ANY PROPOSED CHANGES TO THE DETAILS SHOWN.
- THE ROOFING CONTRACTOR IS TO PROVIDE ALL LABOR AND MATERIAL FOR A COMPLETE AND WATERTIGHT JOB WHICH IS FULLY WARRANTED /GUARANTEED BY THE MANUFACTURER AS PROVIDED FOR IN THE CONTRACT DOCUMENTS. ANY DETAILS OR WORK REQUIRED FOR A COMPLETE JOB, BUT NOT SHOWN OR SPECIFIED BY THE CONTRACT DOCUMENTS, SHALL BE INSTALLED IN ACCORDANCE WITH THE MANUFACTURER'S RECOMMENDATIONS AND REQUIREMENTS AT NO ADDITIONAL COST TO THE OWNER. ANY ADDITIONAL LABOR AND MATERIAL REQUIRED TO MEET MANUFACTURER'S WARRANTY / GUARANTY REQUIREMENTS, BUT NOT INDICATED BY THE CONTRACT DOCUMENTS, SHALL BE PROVIDED AT NO ADDITIONAL COST TO THE OWNER.
- ALL WOOD BLOCKING USED IN THE ROOFING WORK SHALL BE MINIMUM 2X6 PRESSURE TREATED.
- ALL NEW CRICKETS/GUSSETS TO BE TAPERED ISO DOUBLE THE SLOPE OF ROOF(e.g 1/4" PER FOOT FOR $\frac{1}{8}$ " PER FOOT ROOF
- PROVIDE CRICKET BEHIND ALL ROOF CURBS GREATER THAN 24" AT HIGHER SLOPE.
- ADDITIONAL DETAILS NOT KEYED ON ROOF PLAN MAY BE REFERENCED AND SHALL BE INSTALLED AS NECESSARY.

NEW ROOF ASSEMBLY CHART

	DESCRIPTION	SYMBOL	DESCRIPTION	DETAIL	-
	INSTALL NEW ROOF DRAIN ASSEMBLY (4" DIAMETER) . CONNECT ROOF DRAIN ASSEMBLY TO EXISTING DRAIN LINES WITH NO HUB CONNECTION. MATCH EXISTING ROOF DRAIN DIAMETER.	•	ROOF DRAIN IN SUMP	11,12 A-502	
	ROOFING CONTRACTOR SHALL PROVIDE SHOP DRAWING FOR GUSSET/ CRICKET/ ROOF INSULATION LAYOUT FROM ROOFING MANUFACTURER FOR TERRACON REVIEW PRIOR TO INSTALLATION.	o ^v	PLUMBING VENT	9 A-502	
	TEMPORARILY DISCONNECT AND RECONNECT ANY DOORS, MECHANICAL/ELECTRICAL LINES,LIGHTNING PROTECTION SYSTEM AND EQUIPMENT AS NECESSARY TO DISPOSE OF THE ROOF SYSTEM AND RELATED MATERIAL. COORDINATE DISCONNECTION AND RECONNECTION WITH OWNER. THE ROOFING CONTRACTOR SHALL REMOVE ALL EXISTING ITEMS WHICH INTERFERE WITH THE INSTALLATION OF THE NEW ROOF	°PP	PIPE PENETRATION		
	SYSTEM AND RELATED WORK. ALL SUCH EQUIPMENT AND ITEMS SHALL BE TEMPORARILY RE—ROUTED AS NECESSARY IF IT REQUIRED TO STAY IN SERVICE. LIGHTNING PROTECTION SYSTEM SHALL REMAIN IN SERVICE AT ALL TIMES. ANY ITEMS NOT REQUIRED TO STAY IN SERVICE SHALL BE PROPERLY STORED BY THE SUB CONTRACTOR AND REINSTALLED AT THE COMPLETION OF THE WORK. ALL ELECTRICAL, MECHANICAL AND PLUMBING WORK SHALL BE PERFORMED BY LICENSED CONTRACTORS. ALL REINSTALLED WORK SHALL BE PERFORMED AT NO ADDITIONAL COST TO THE OWNER. ANY EXISTING WORK WHICH DOES NOT CONFORM TO APPLICABLE CURRENT CODES SHALL BE REPORTED TO OWNER.	۵	POWER VENT	7,8 A-501	
_	(NOT USED)	— ы—	EXPANSION JOINT	14 A-505 (A-503)	
	WATER AND		GUSSET/ CRICKET (TWICE SLOPE OF ROOF)		
	INSTALL 18" WIDE MINIMUM PMMA REINFORCED FLASHING SYSTEM TIEING EXISTING ROOF ASSEMBLY AND NEW EXPANSION JOINT. PROVIDE WATERTIGHT CONDITIONS.	.00:FT (+/-)	TAPERED ROOF SLOPE		
		(0.0")	INDICATES THICKNESS OF INSULATION OVERLAY BOARD THICKNESS IS NOT INCLUDED. [H.P. INDICATES HIGHPOINT, L.P INDICATES LOW POINT]		
		7	DOOR THRESHOLD	16 A-503	
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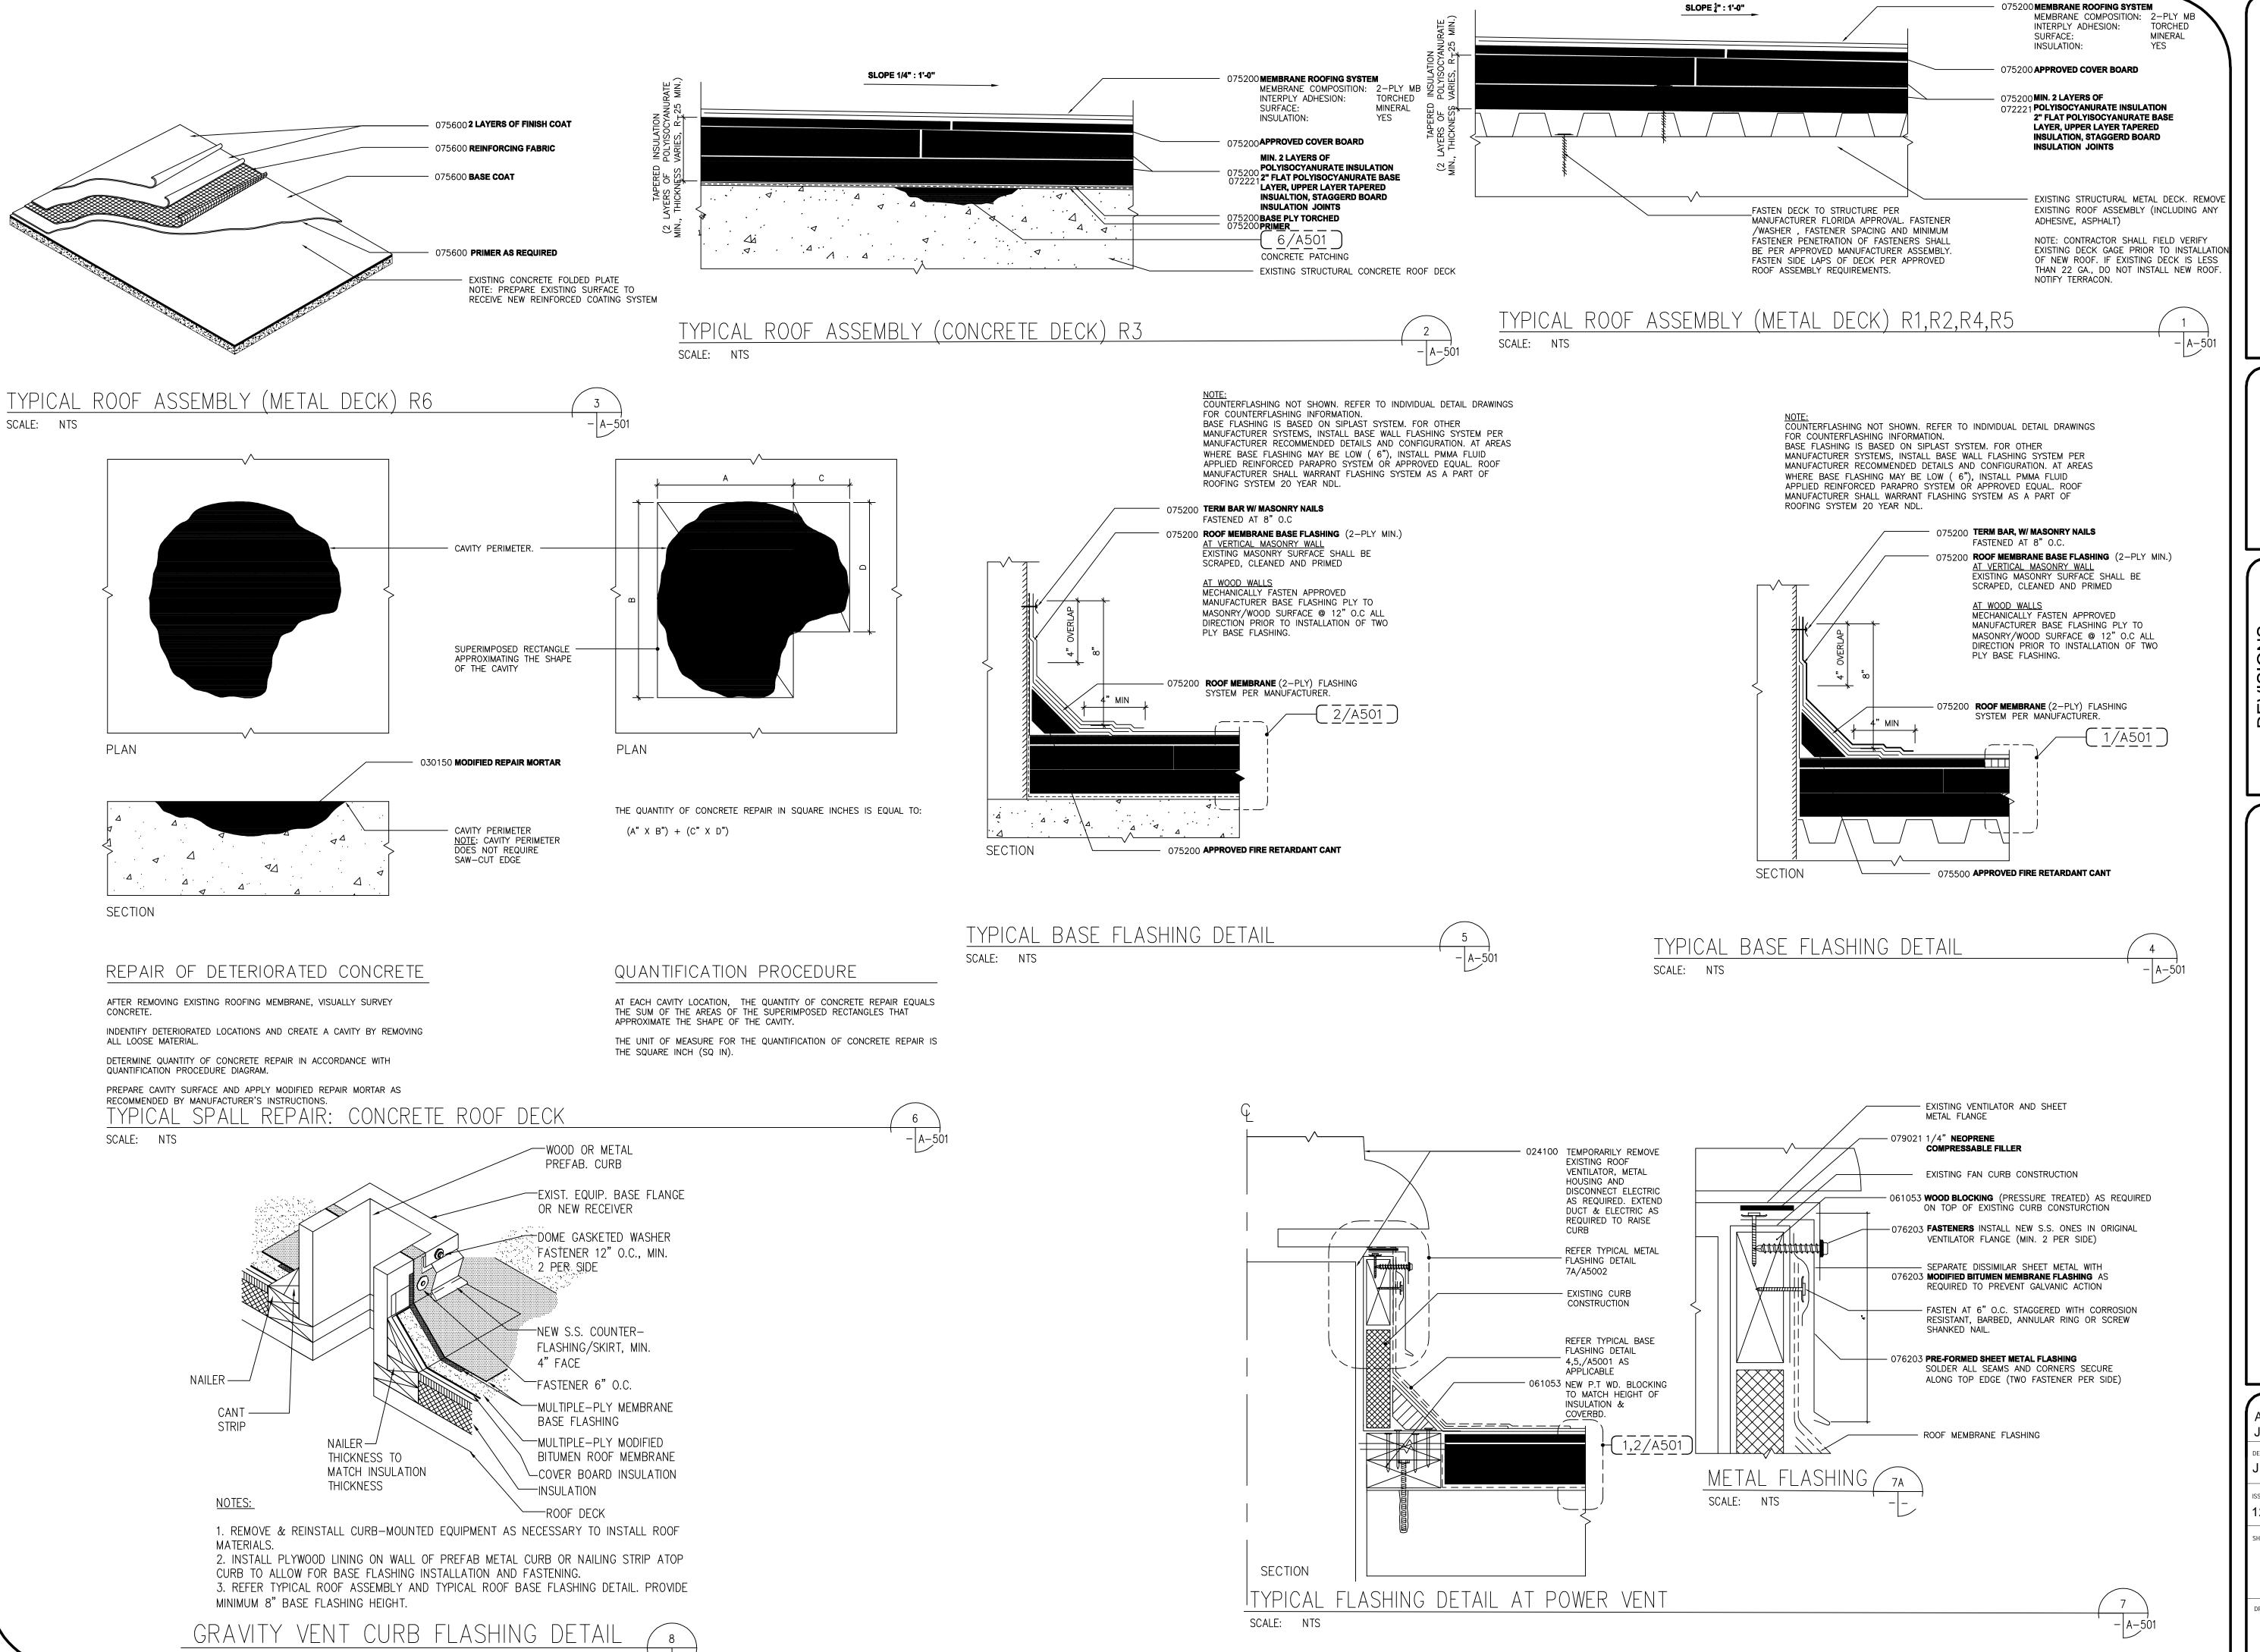
		1								1			
		STRUCTURAL	DECK		INITIAL PLY	INSULATION	INSULATION	ATTACHMENT	COVER BOARD	COVER BOARD ATTACHMEN T	ROOF MEMBRANE	COATING	COMMENTS
)	ROOF DESIGNATION	METAL DECK	CONCRETE	CONCRETE FOLDED PLATES	BASE PLY TORCHED	TAPERED POLYISOCYANURATE (R-25), TWO LAYERS, BOTTOM LAYER 2" THICK, TOP LAYER TAPERED	BSE LAYER MECHANICALLY FASTENED, TOP LAYER ADHERED	BASE LAYER ADHERED, TOP LAYER ADHERED	APPROVED COVERBOARD	ADHERED	2 PLY MODIFIED BITUMEN TORCHED (CAP PLY GRANULATED)	FLUID APPLIED REINFORCED COATING SYSTEM	● REFERS (APPLICABLE) - REFERS (NOT APPLICABLE) (*) MANUFACTURER WARRANTY (20 YEAR NDL SYSTEM) (a) INDICATES SMALL ROOF AREAS REQUIRING TAPERED SYSTEM (*) 1 4-500
	R1	•	I	-	_	•	•	_	•	•	•	_	(*) (1)
	R2	•	_	_	_	•	•	_	•	•	•	_	(*) (2) (-50)
	R3	_	•	_	•	•	_	•	•	•	•	_	(*) (-50)
_	R4	•	_	_	_	•	•	_	•	•	•	_	(*) (*) (*) (*) (*) (*) (*) (*) (*) (*)
	R5	•	_	-	_	•	•	_	•	•	•	_	(*) (2)
	R6	_	_	•	_	_	_	_	_	_	<u> </u>	•	4-50)
	R7	_	•	_	_	•	_	•	•	•	•	_	

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REVISIONS	DOCUMENT HISTORY	DESCRIPTION					
		DATE					
		NO.					

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rchitect IM SAIZAN	ARCH/ENGR OF RECORD						
SIGNED BY	JMP						
ue date 2/21/2022	AE PROJECT NUMBER F9196119						
NEW ROOF PLAN							
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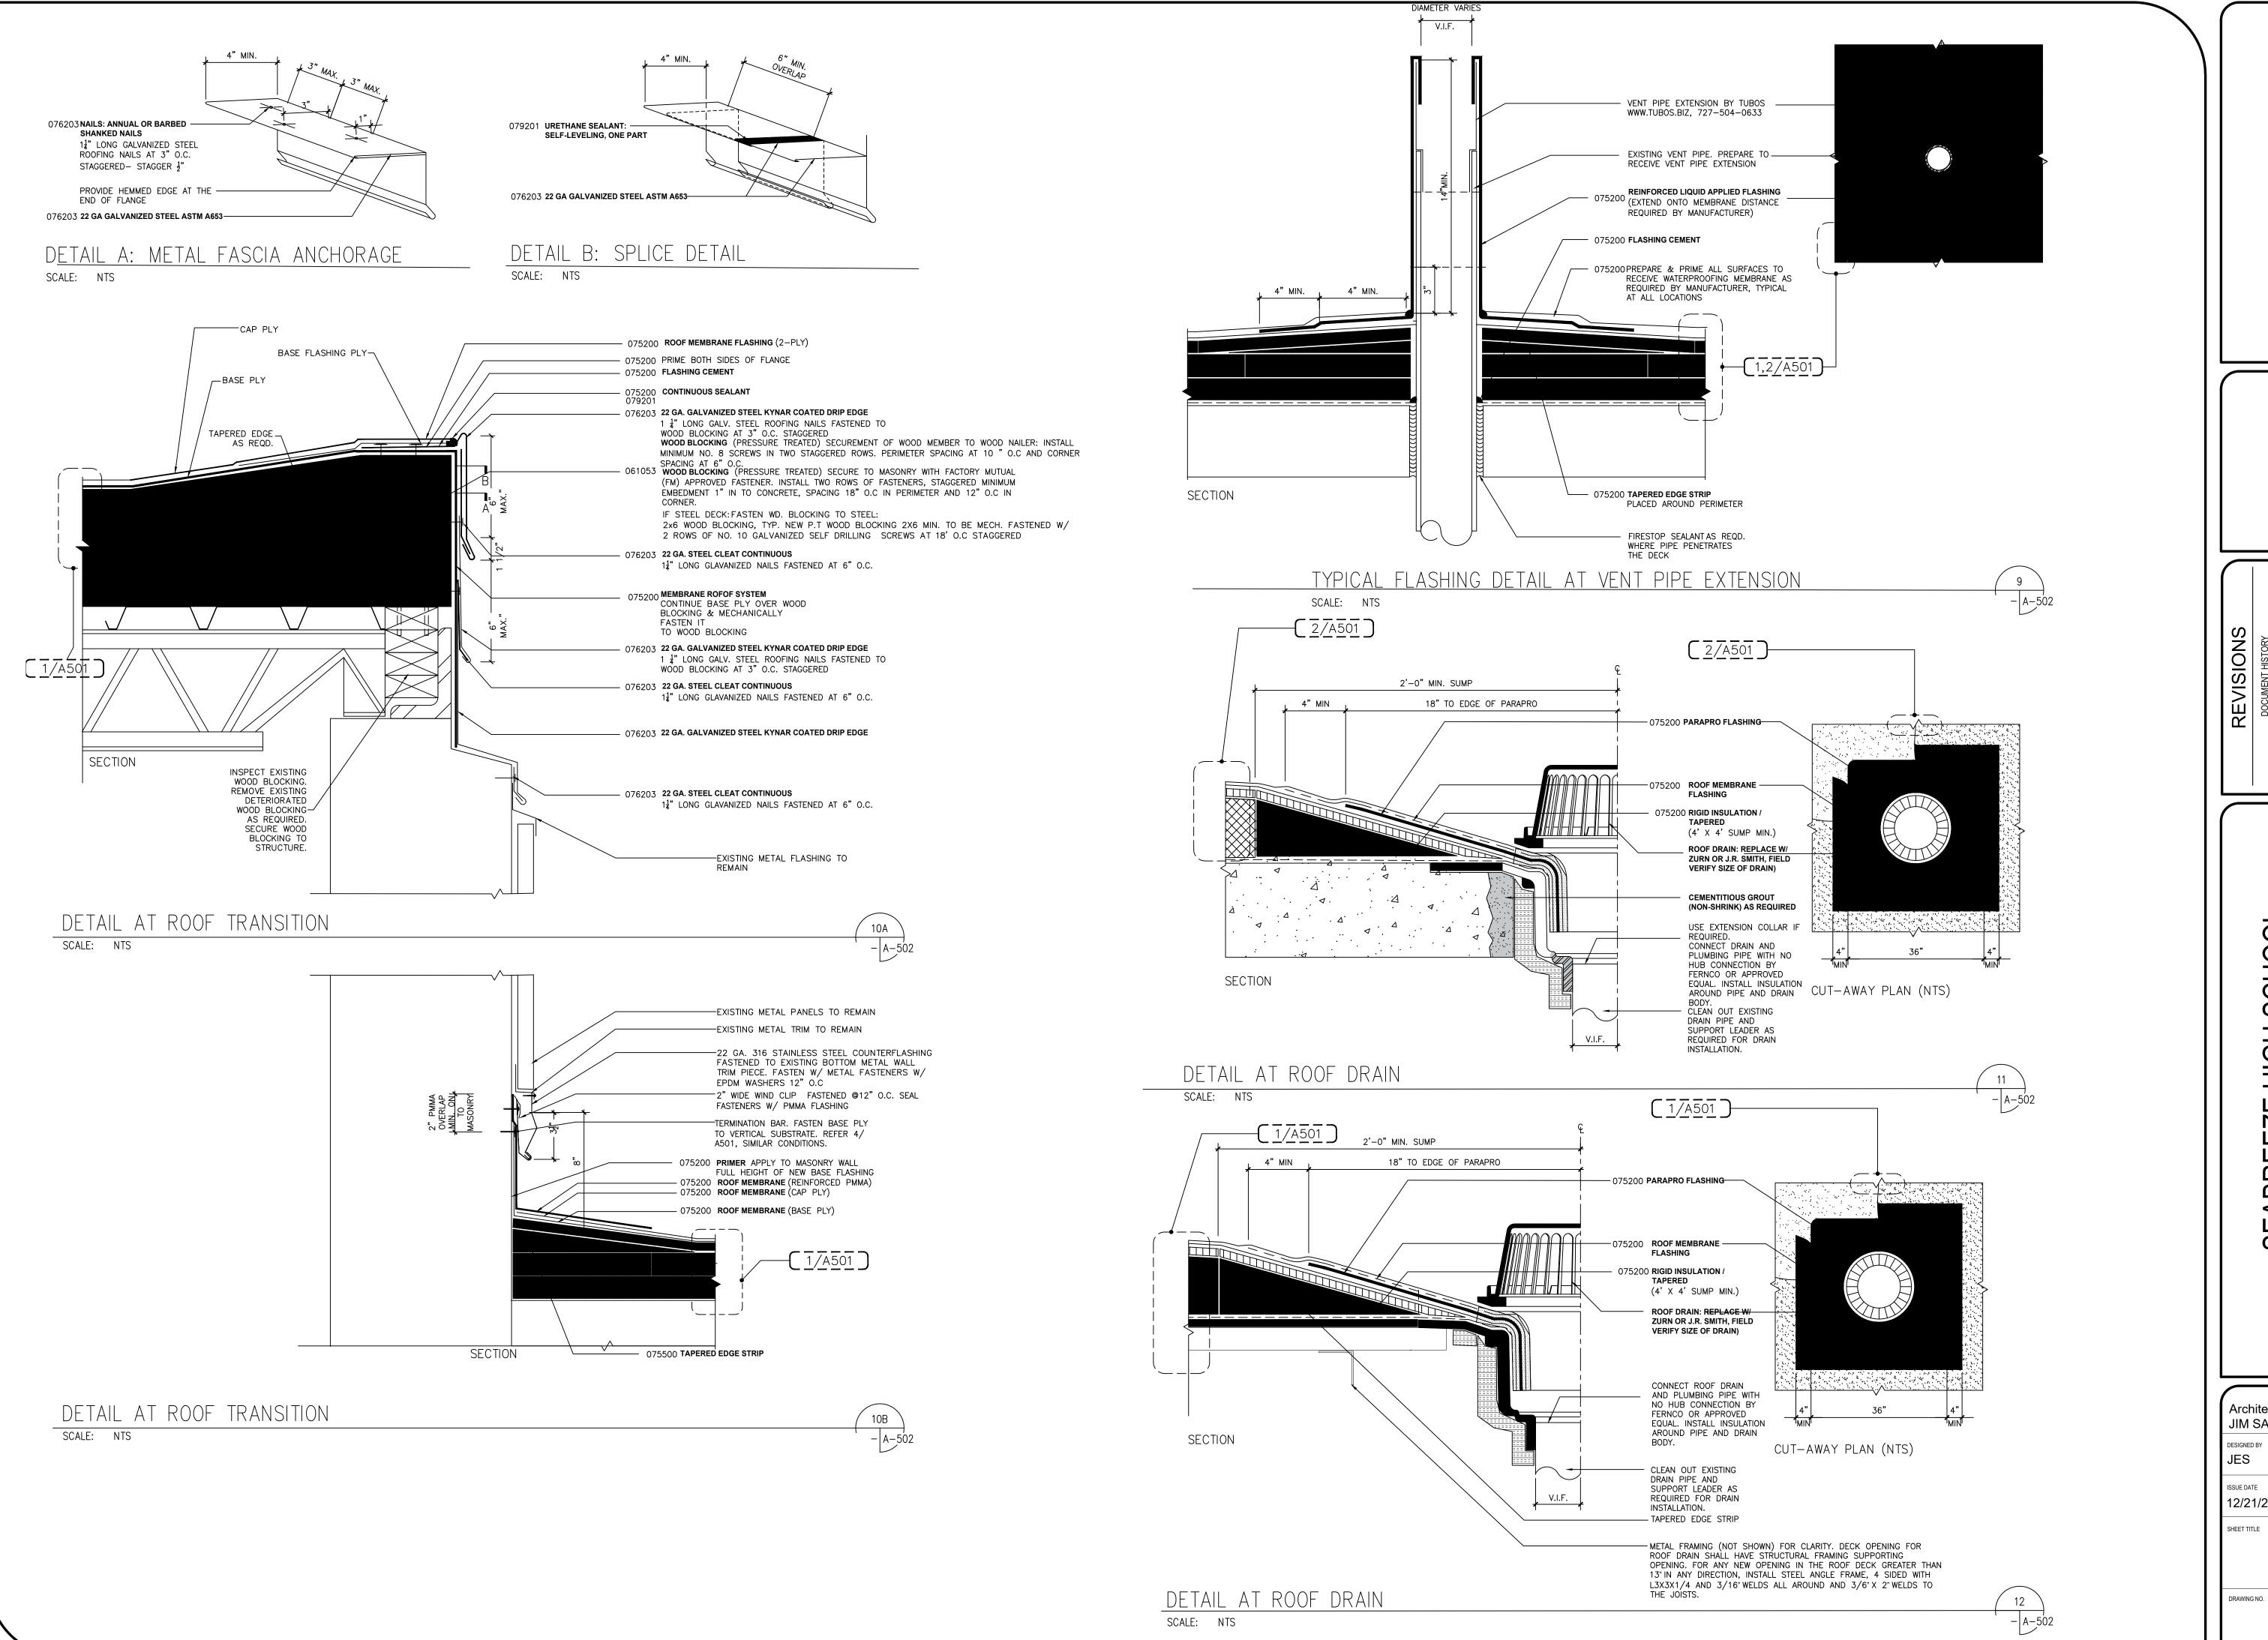
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2700 NORTH C DAYTONA I

ARCH/ENGR OF RECORI Architect JIM SAIZAN DRAWN BY JMP AE PROJECT NUMBER 12/21/2022 F9196119

ROOF DETAILS

A-501



Sonsulting Engineers and Scientists

EE ROAD

WINTER PARK, FLORIDA 32789

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DOCUMENT HISTORY
DATE
DESCRIPTION

SEABREEZE HIGH SCHOOL
REROOF MEDIA CENTER
VCS Project NO. 194737

2700 NORTH OLEANDER AVENUE
DAYTONA BEACH, FL 32118

ARCH/ENGR OF RECORD

Architect
JIM SAIZAN

DESIGNED BY
JES

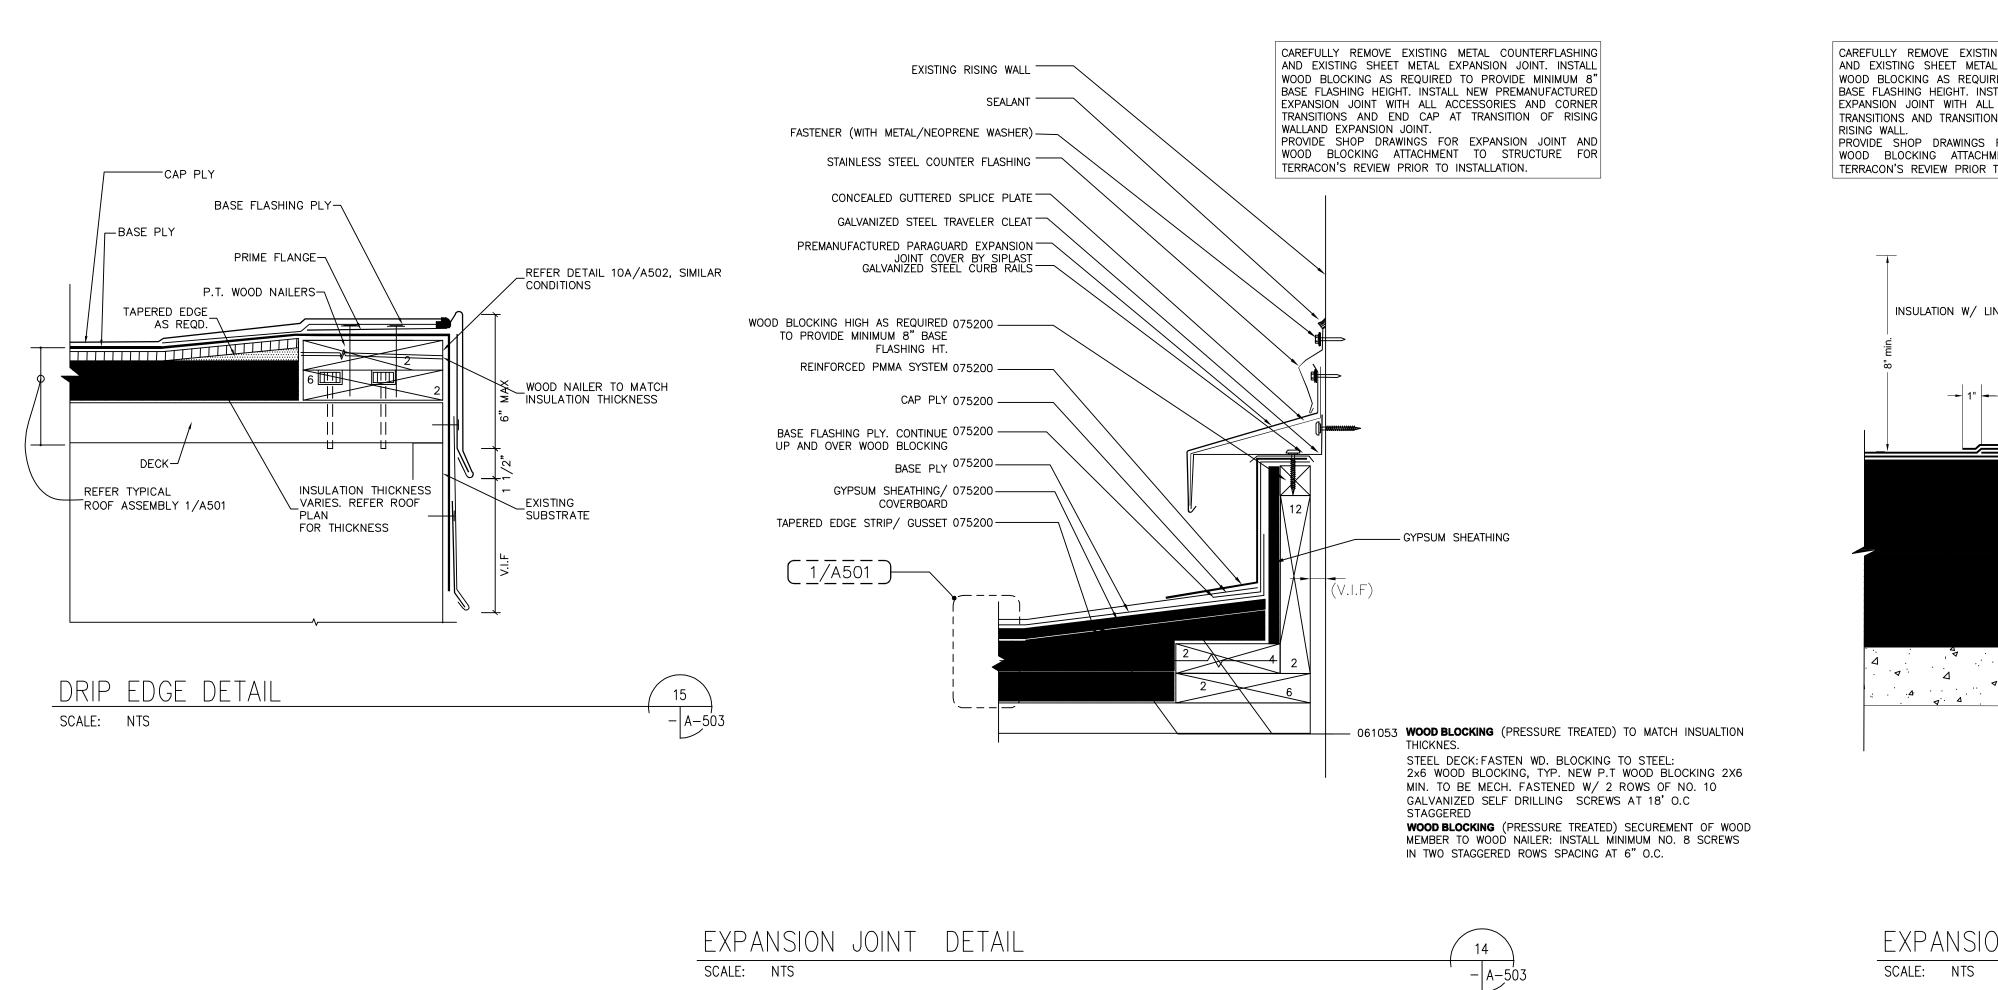
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12/21/2022

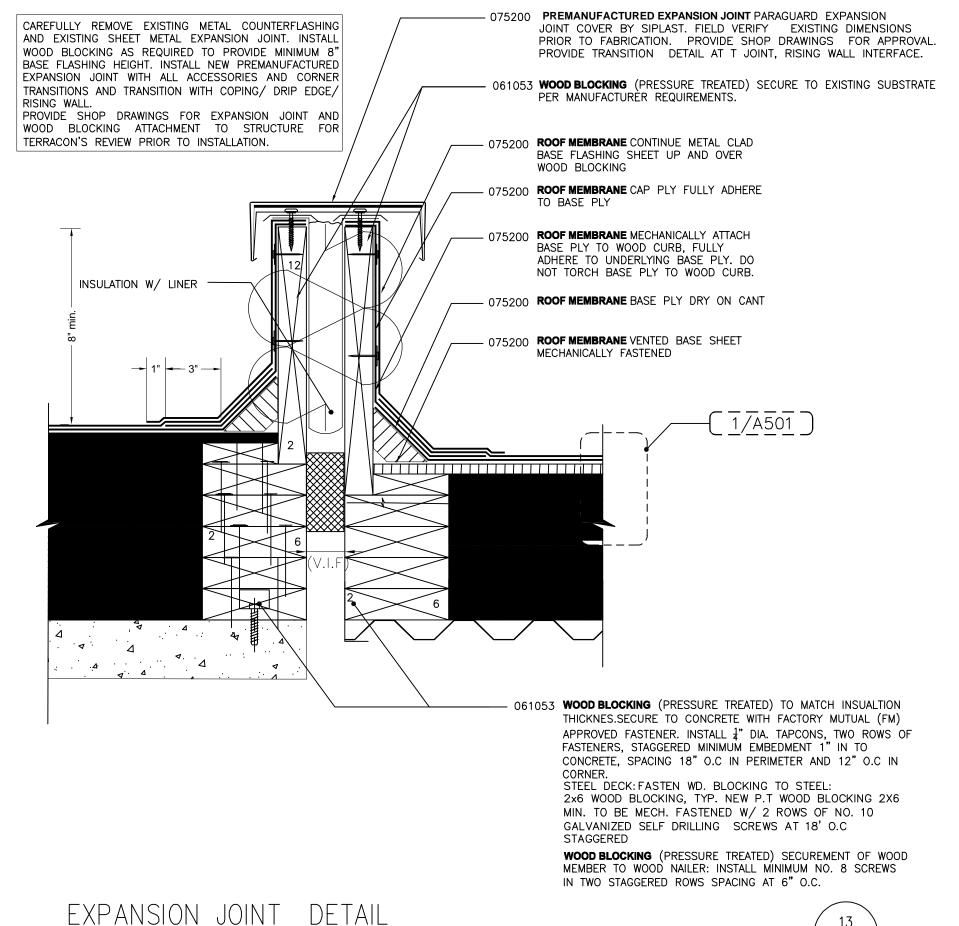
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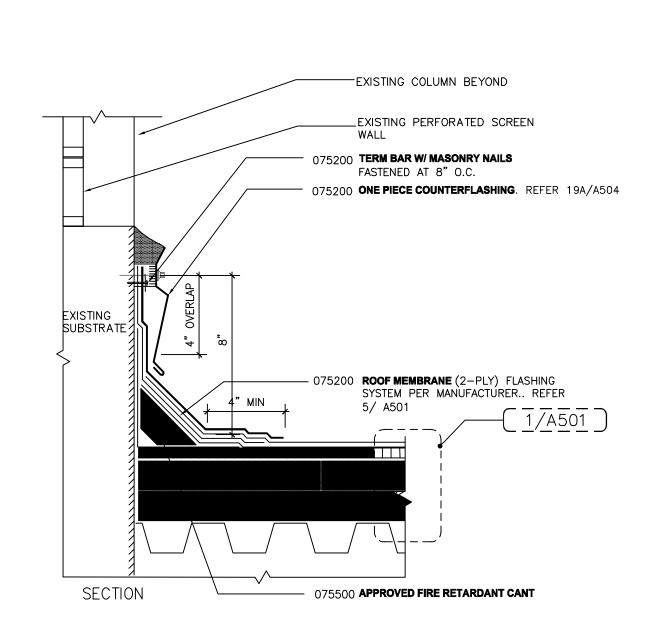
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ROOF DETAILS

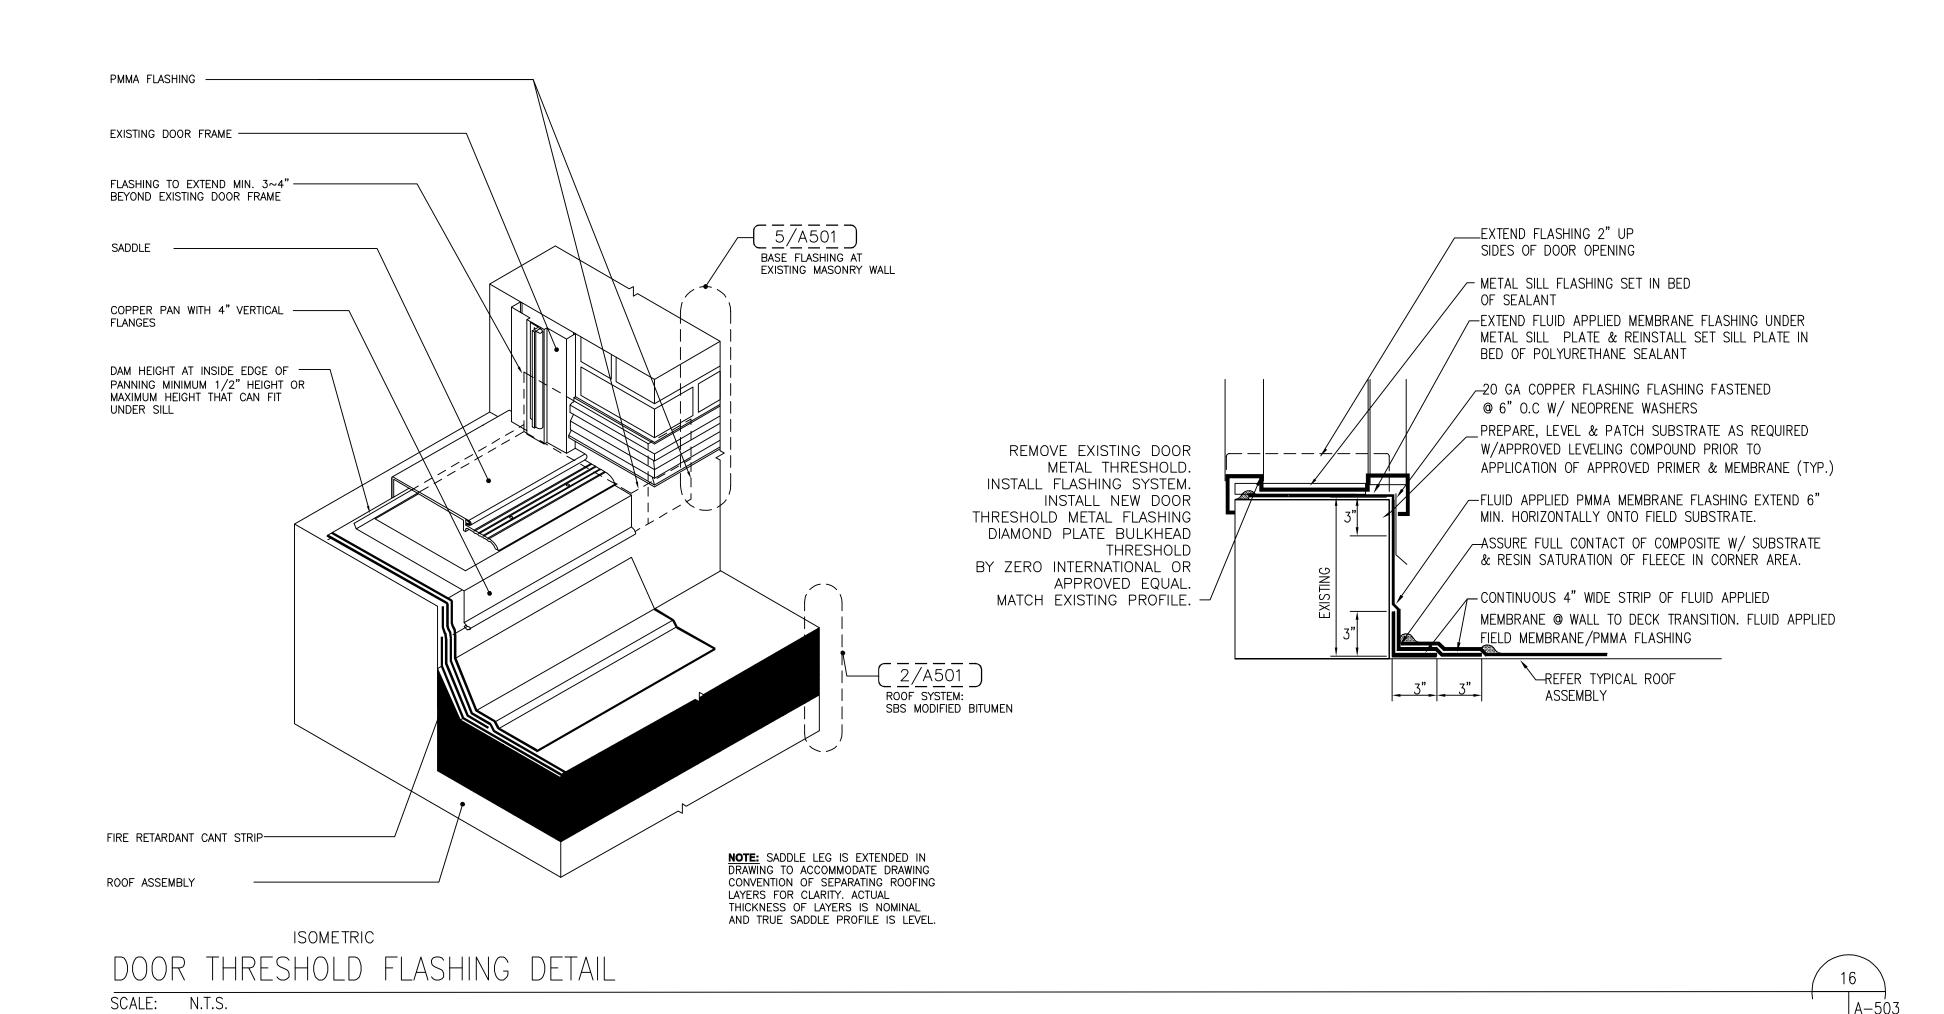
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SEABREEZE HIGH SCHOO REROOF MEDIA CENTER VCS Project NO. 194737

Architect JIM SAIZAN	ARCH/ENGR OF RECORD						
DESIGNED BY JES	JMP						
12/21/2022	AE PROJECT NUMBER F9196119						
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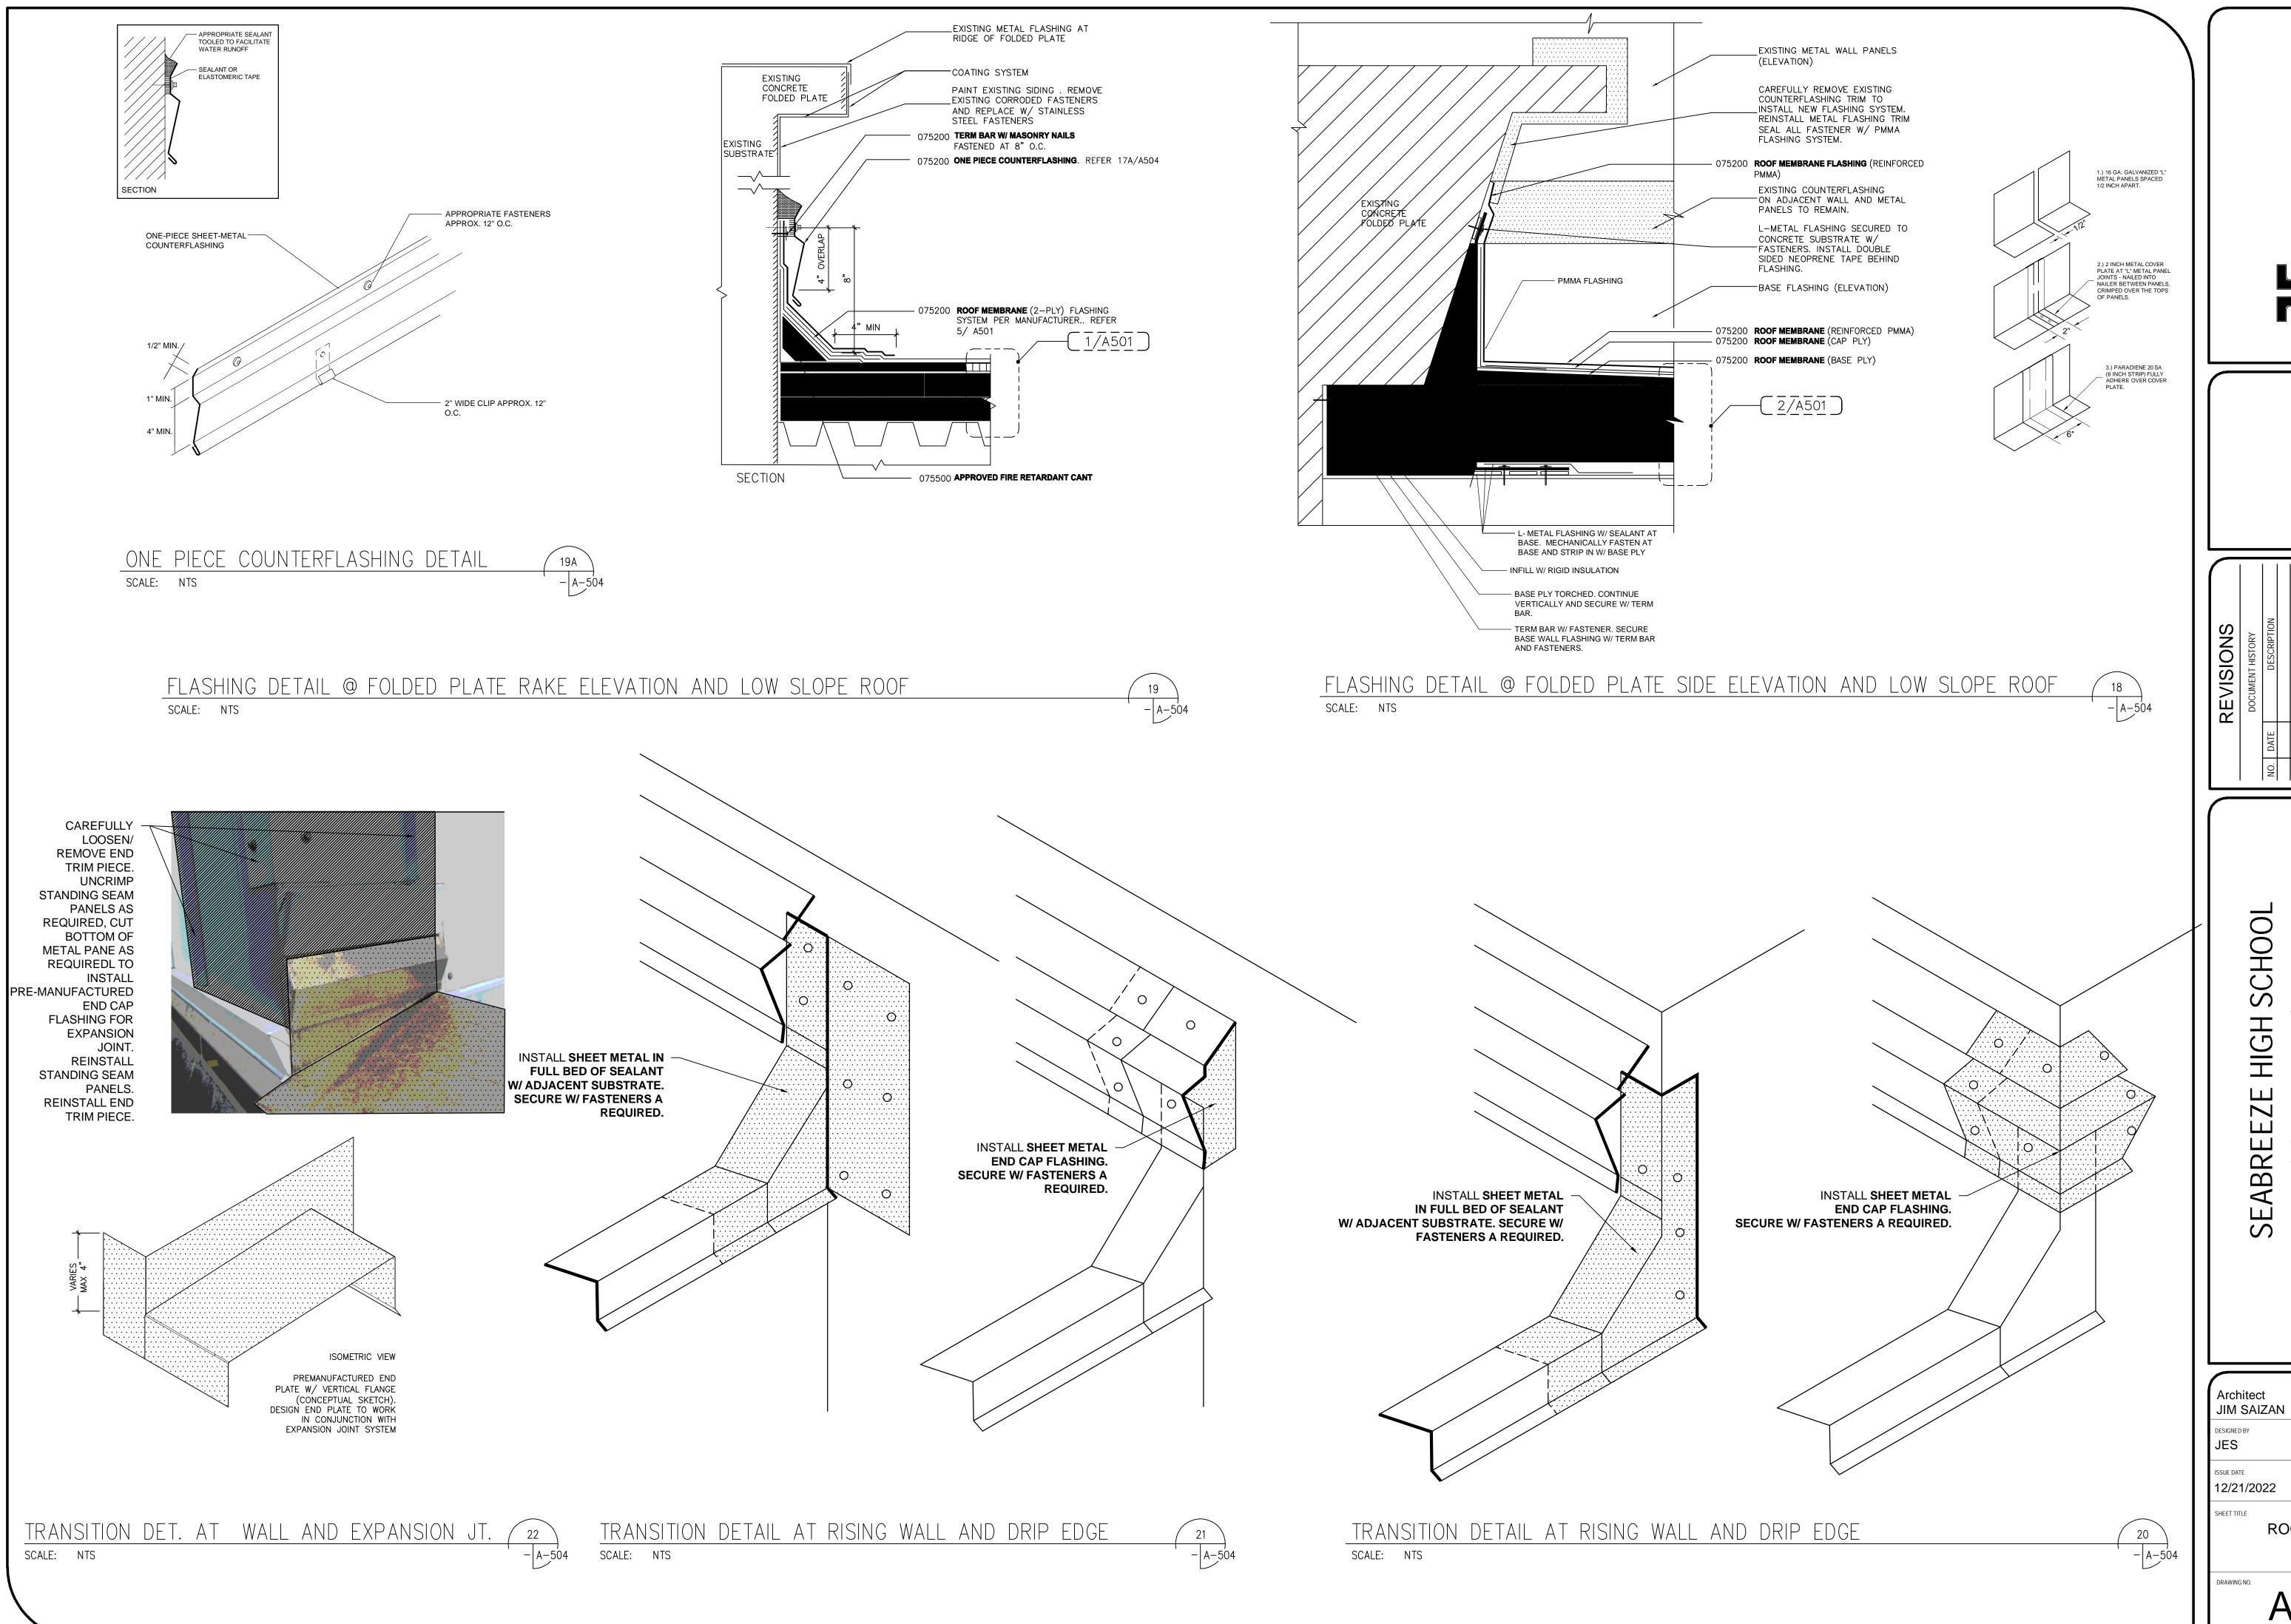
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2700 NORTH OLEANDER AVENUE DAYTONA BEACH, FL 32118 CENTER 194737 REROOF MEDIA C VCS Project NO. 1

ARCH/ENGR OF RECORD JMP AE PROJECT NUMBER F9196119

ROOF DETAILS

A-504